ACTON WATERFRONT

ELECTRICAL SERVICES

DRAWING LIST

DOCUMENT NO.	TITLE	DOCUMENT NO.	TITLE
SYD21128-EL-SP-500	COVER SHEET - STAGES 1A, 1B AND 2 - ELECTRICAL SERVICES	SYD21128-EL-SP-902	SCOPE OF WORKS STAGE 2 - ELECTRICAL SERVICES
SYD21128-EL-SP-501	LEGEND - ELECTRICAL & MECHANICAL SERVICES		
SYD21128-EL-SP-502	SCOPE OF WORKS STAGE 1A - ELECTRICAL SERVICES	SYD21128-EL-SP-910	EXISTING LIGHTING - OVERVIEW - ELECTRICAL SERVICES
SYD21128-EL-SP-503	SCOPE OF WORKS STAGE 1B - ELECTRICAL SERVICES	SYD21128-EL-SP-911	EXISTING LIGHTING - SHEET 1 - ELECTRICAL SERVICES
		SYD21128-EL-SP-912	EXISTING LIGHTING - SHEET 2 - ELECTRICAL SERVICES
SYD21128-EL-SP-505	PUBLIC LIGHTING CATEGORY PLAN STAGE 1A - ELECTRICAL SERVICES		
SYD21128-EL-SP-506	PUBLIC LIGHTING CATEGORY PLAN STAGE 1B - ELECTRICAL SERVICES	SYD21128-EL-SP-920	NEW LIGHTING STAGE 2 - OVERVIEW - ELECTRICAL SERVICES
		SYD21128-EL-SP-921	NEW LIGHTING STAGE 2 - SHEET 1 - ELECTRICAL SERVICES
SYD21128-EL-SP-510	EXISTING LIGHTING - OVERVIEW - ELECTRICAL SERVICES	SYD21128-EL-SP-922	NEW LIGHTING STAGE 2 - SHEET 2 - ELECTRICAL SERVICES
SYD21128-EL-SP-511	EXISTING LIGHTING - SHEET 1 - ELECTRICAL SERVICES		
SYD21128-EL-SP-512	EXISTING LIGHTING - SHEET 2 - ELECTRICAL SERVICES	SYD21128-EL-SP-925	PUBLIC LIGHTING CATEGORY PLAN STAGE 2 - ELECTRICAL SERVICES
SYD21128-EL-SP-520	NEW LIGHTING STAGE 1A - OVERVIEW - ELECTRICAL SERVICES	SYD21128-EL-SP-930	EXISTING INGROUND SERVICES - OVERVIEW - ELECTRICAL SERVICES
SYD21128-EL-SP-521	NEW LIGHTING STAGE 1A - SHEET 1 - ELECTRICAL SERVICES	SYD21128-EL-SP-931	EXISTING INGROUND SERVICES - SHEET 1 - ELECTRICAL SERVICES
SYD21128-EL-SP-522	NEW LIGHTING STAGE 1A - SHEET 2 - ELECTRICAL SERVICES	SYD21128-EL-SP-932	EXISTING INGROUND SERVICES - SHEET 2 - ELECTRICAL SERVICES
SYD21128-EL-SP-525	NEW LIGHTING STAGE 1B - OVERVIEW - ELECTRICAL SERVICES	SYD21128-EL-SP-940	NEW INGROUND SERVICES STAGE 2 - OVERVIEW - ELECTRICAL SERVICES
SYD21128-EL-SP-526	NEW LIGHTING STAGE 1B - SHEET 1 - ELECTRICAL SERVICES	SYD21128-EL-SP-941	NEW INGROUND SERVICES STAGE 2 - SHEET 1 - ELECTRICAL SERVICES
SYD21128-EL-SP-527	NEW LIGHTING STAGE 1B - SHEET 2 - ELECTRICAL SERVICES	SYD21128-EL-SP-942	NEW INGROUND SERVICES STAGE 2 - SHEET 2 - ELECTRICAL SERVICES
SYD21128-EL-SP-530	EXISTING INGROUND SERVICES - OVERVIEW - ELECTRICAL SERVICES	SYD21128-EL-SP-950	DRAWING REMOVED
SYD21128-EL-SP-531	EXISTING INGROUND SERVICES - SHEET 1 - ELECTRICAL SERVICES	SYD21128-EL-SP-951	DETAIL 1 - PLAY PAVILION - LIGHTING, POWER & MECHANICAL LAYOUTS
SYD21128-EL-SP-532	EXISTING INGROUND SERVICES - SHEET 2 - ELECTRICAL SERVICES	SYD21128-EL-SP-952	DETAIL 2 - ARRIVAL PAVILION - LIGHTING, POWER & MECHANICAL LAYOUTS
SYD21128-EL-SP-540	NEW INGROUND SERVICES STAGE 1A - OVERVIEW - ELECTRICAL SERVICES	SYD21128-EL-SP-960	SINGLE LINE DIAGRAM - ELECTRICAL SERVICES
SYD21128-EL-SP-541	NEW INGROUND SERVICES STAGE 1A - SHEET 1 - ELECTRICAL SERVICES		
SYD21128-EL-SP-542	NEW INGROUND SERVICES STAGE 1A - SHEET 2 - ELECTRICAL SERVICES		
SYD21128-EL-SP-545	NEW INGROUND SERVICES STAGE 1B - OVERVIEW - ELECTRICAL SERVICES		

NEW INGROUND SERVICES STAGE 1B - SHEET 1 - ELECTRICAL SERVICES

NEW INGROUND SERVICES STAGE 1B - SHEET 2 - ELECTRICAL SERVICES

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SYD21128-EL-SP-546

SYD21128-EL-SP-547

	CITY RENEWAL AUTHORITY	Landscape Architect ASPECT STUDIOS		Project ACTON WATERFRONT	Drawing Title COVER SHEET - STAGES 1A, 1B AND ELECTRICAL SERVICES	 D 2
			Fyshwick ACT 2609			ACOR PROJECT No: ACT2105
			T +61 2 6240 2900		Drawn Q.A. Check	Date Scale
					D. Ortiz MV	12.05.23 N.T.S
02 FOR WORKS APPROVAL 12.05.23 DO AB			CONICIUTANTS		Designed Project No.	Dwg. No. Issue
Issue Description Date Drawn Approved			CONSULTANTS CALIFORNIA CONSULTANTS	FOR APPROVAL	A. Bencke SYD21128-EL-SI	P 500 02

					LUN	IINAIRES				
SYMBOL	LIGHT SOURCE WATTAGE LUMENS	COLOUR TEMP (CRI)	MOUNTING STYLE (IP)	OPTIC	COLOUR	CONTROL	STATU MAKE AND MODE			ADDITIONAL REQUIREMENTS
Ç ^{DEM}	-	-	-	-	-	-	EXISTING STREETLIGHT TO BE REMOVED		D	-
Ŷ	-	-	-	-	-	-	EXISTING STREETLI	IGHT TO REMAIN		-
E •	LED 72W	4000K	MOUNTED ON 6m COLUMN	S60	-	-	EXISTI WE-EF VFL540			-
2xL	LED 6W	3000K	CONCRETE RECESSED IP68	120° WALL WASH	-	-	EXISTI DIGILIN TAIP <i>i</i>			-
P	LED 72W 7,550lm	4000K	MOUNTED ON 9m COLUMN WITH 3m OUTREACH ARM	R65	GREY ALUMINIUM	PE CELL AND NEMA BASE	NEW WE-EF VFL			COLUMN TYPE SHALL BE MULTIPOLE. DEM = DENOTES IN STALLED IN ONE STAGE AND REMOVED IN ANOTHER. REFER TO THE NOTES ON THE DRAWINGS.
₿	LED 48W 5,840lm	4000K	MOUNTED ON COLUMN AT 6m AFFL WITH 0.6m OUTREACH ARM	R65	GREY ALUMINIUM	PE CELL AND NEMA BASE	NEW WE-EF VFL			COLUMN TYPE SHALL BE MULTIPOLE.
©	LED 48W 5,840lm	4000K	MOUNTED ON 6m COLUMN	R65	ELECTRO MEDIUM BRONZE	PE CELL AND NEMA BASE		NEW WE-EF VFL540-SE		COLUMN TYPE SHALL BE TAPERED ROUND, WITH RAG BOLT ASSEMBLY, CUSTOM TOP AND COLOUR ELECTRO MEDIUM BRONZE TO MATCH HENRY ROLAND PARK COLUMNS. DEM = DENOTES IN STALLED IN ONE STAGE AND REMOVED IN ANOTHER. REFER TO THE NOTES ON THE DRAWINGS.
0	LED	4000K	HANDRAIL LIGHTING	ASYMMETRICAL	-	-	NEW HANDRAIL LU			-
P	LED 24W	4000K	MOUNTED ON 6m COLUMN	A60	ELECTRO MEDIUM BRONZE	PE CELL AND NEMA BASE	NEW WE-EF VFL			COLUMN TYPE SHALL BE TAPERED ROUND, WITH RAG BOLT ASSEMBLY, CUSTOM TOP AND COLOUR ELECTRO MEDIUM BRONZE TO MATCH HENRY ROLAND PARK COLUMNS.
Ģ	LED 48W 5,840lm	4000K	MOUNTED ON 9m COLUMN. LUMINAIRE SHALL BE MOUNTED AT 6m AFGL WITH 0.6m OUTREACH ARM	R65	GREY ALUMINIUM	PE CELL AND NEMA BASE	NEW WE-EF VFL			COLUMN TYPE SHALL BE MULTIPOLE. COLUMN HEIGHT OF 9m IS TO ALOW FOR FUTURE INSTALLATION OF TYPE 'A' LUMINAIRE.
Φ.	LED 24W	4000K	MOUNTED ON 6m COLUMN	R65	ELECTRO MEDIUM BRONZE	PE CELL AND NEMA BASE	NEW WE-EF VFL			COLUMN TYPE SHALL BE TAPERED ROUND, WITH RAG BOLT ASSEMBLY, CUSTOM TOP AND COLOUR ELECTRO MEDIUM BRONZE TO MATCH HENRY ROLAND PARK COLUMNS.
0	LED	4000K	SURFACE MOUNTED	ТВС	ТВС	MOTION SENSOR OR PE CELL	NEW DOWNLIGH			-
S	LED 20W 2880lm	4000K	SURFACE MOUNTED (IP67, IK09)	WIDE BEAM	BLACK	MOTION SENSOR	NEW WE-EF VI			-
		LIGHTING)		Р	OWER		CON	IDUITS	S & INGROUND SERVICES
SYMBOL		DESCR	RIPTION	SYMBOL		DESCRIPTION	ON	LINETYPE DENO		SERVICE TYPE
Д	NEW MOTION SE	NSOR.		\forall	SINGLE OR DOUBLE GENERAL PURPOSE POWER OUTLET. EQUAL TO HPM EXCEL LIFE OR CLIPSAL 2000 RANGE. REFER TO STANDARD NOTATIONS ADJACENT LEGEND.			REMOVED		
PE		CONTROL EXTER	RNAL LIGHTING. PE CELL SHALL BE DN SYSTEM.		XISTING MINIPILLA	R TO REMAIN.				LD LIGHT DUTY 100 CONDUIT DIAMETER 2 x QUANTITY OF CONDUITS
					XISTING METER PA			SYMBOL		DESCRIPTION
				CC N	I = NEW.		CUBICLE TO REMAIN.	eHV	CONDUIT ORANGE H	TAGE CONDUITS. LOCATIONS SHOWN ARE INDICATIVE ONLY. HDU-PVC ELECTRICAL CONDUIT, SIZE AND QUANTITY AS
				N	I = NEW.	ON OR SWITCHBOA	ARD TO REMAIN.	LV	LOW VOLT	O ON DRAWING. FAGE CONDUITS LOCATIONS SHOWN ARE INDICATIVE ONLY.
				РВ	IEW POWER BOX.			eLV	INDICATED	HDU-PVC ELECTRICAL CONDUIT, SIZE AND QUANTITY AS DON DRAWING. MUNICATIONS CONDUITS.
				WB N	IEW WATERPLAY C	ONTROL BOARD.		— eNBN - — —— eNBN ——	CONDUIT I WHITE PV INDICATED	LOCATIONS SHOWN ARE INDICATIVE ONLY. C COMMUNICATIONS CONDUIT, SIZE AND QUANTITY AS D ON DRAWING.
									WHITE PV	CATIONS CONDUITS. C COMMUNICATIONS CONDUIT, SIZE AND QUANTITY AS D ON DRAWING.
				OVALDO)		UNICATIO		PIT	C = DENO	S C AND DRAINED. TES COMMUNICATIONS PIT. TES ELECTRICAL PIT.
					IEW NBN NETWORK	DESCRIPTION OF THE PROPERTY OF			X = DENOT D = E =	TES PIT STATUS. EXISTING PIT TO BE DEMOLISHED. EXISTING PIT TO REMAIN. NEW PIT.
				l l		CATIONS CABINET	TO REMAIN.			= RELOCATED EXISTING PIT.
				COM N	I = NEW.					

NOTATIONS FOR POWER & COMMUNICATIONS

NOTATION	DESCRIPTION
15A	15Amp SINGLE PHASE OUTLET.
XXASP	SINGLE PHASE OUTLET AMPERE RATING
XXATP	THREE PHASE OUTLET AMPERE RATING
С	MOUNTED ON UNDERSIDE OF CEILING.
В	INSTALLED 300mm ABOVE BENCH OR DESK TOP OR AS SHOWN ON ARCHITECTURAL ELEVATIONS DRAWINGS.
WP	WEATHERPROOF OUTLET (IP56).

NUMBERS ADJACENT (LESS THAN 100) DENOTES MULTIPLE NUMBER OF OUTLETS. NUMBERS ADJACENT (GREATER THAN 100) DENOTES MOUNTING HEIGHT TO THE CENTRELINE OF OUTLET.

INSTALL THE OUTLETS AT 350 AFFL TO CENTERLINE OF OUTLET UNLESS SHOWN OTHERWISE.

MECHANICAL DESCRIPTION SYMBOL ROOF MOUNTED EXHAUST FAN 30mm DOOR UNDERCUT 600x450 DOOR GRILLE 200x200 EXHAUST GRILLE

ASPECT STUDIOS

CITY RENEWAL AUTHORITY

GENERAL NOTE:

 ALL CONDUIT SIZES WILL BE CONFIRMED IN THE NEXT DOCUMENTATION ISSUE, ONCE USER REQUIREMENTS HAVE BEEN CONFIRMED.


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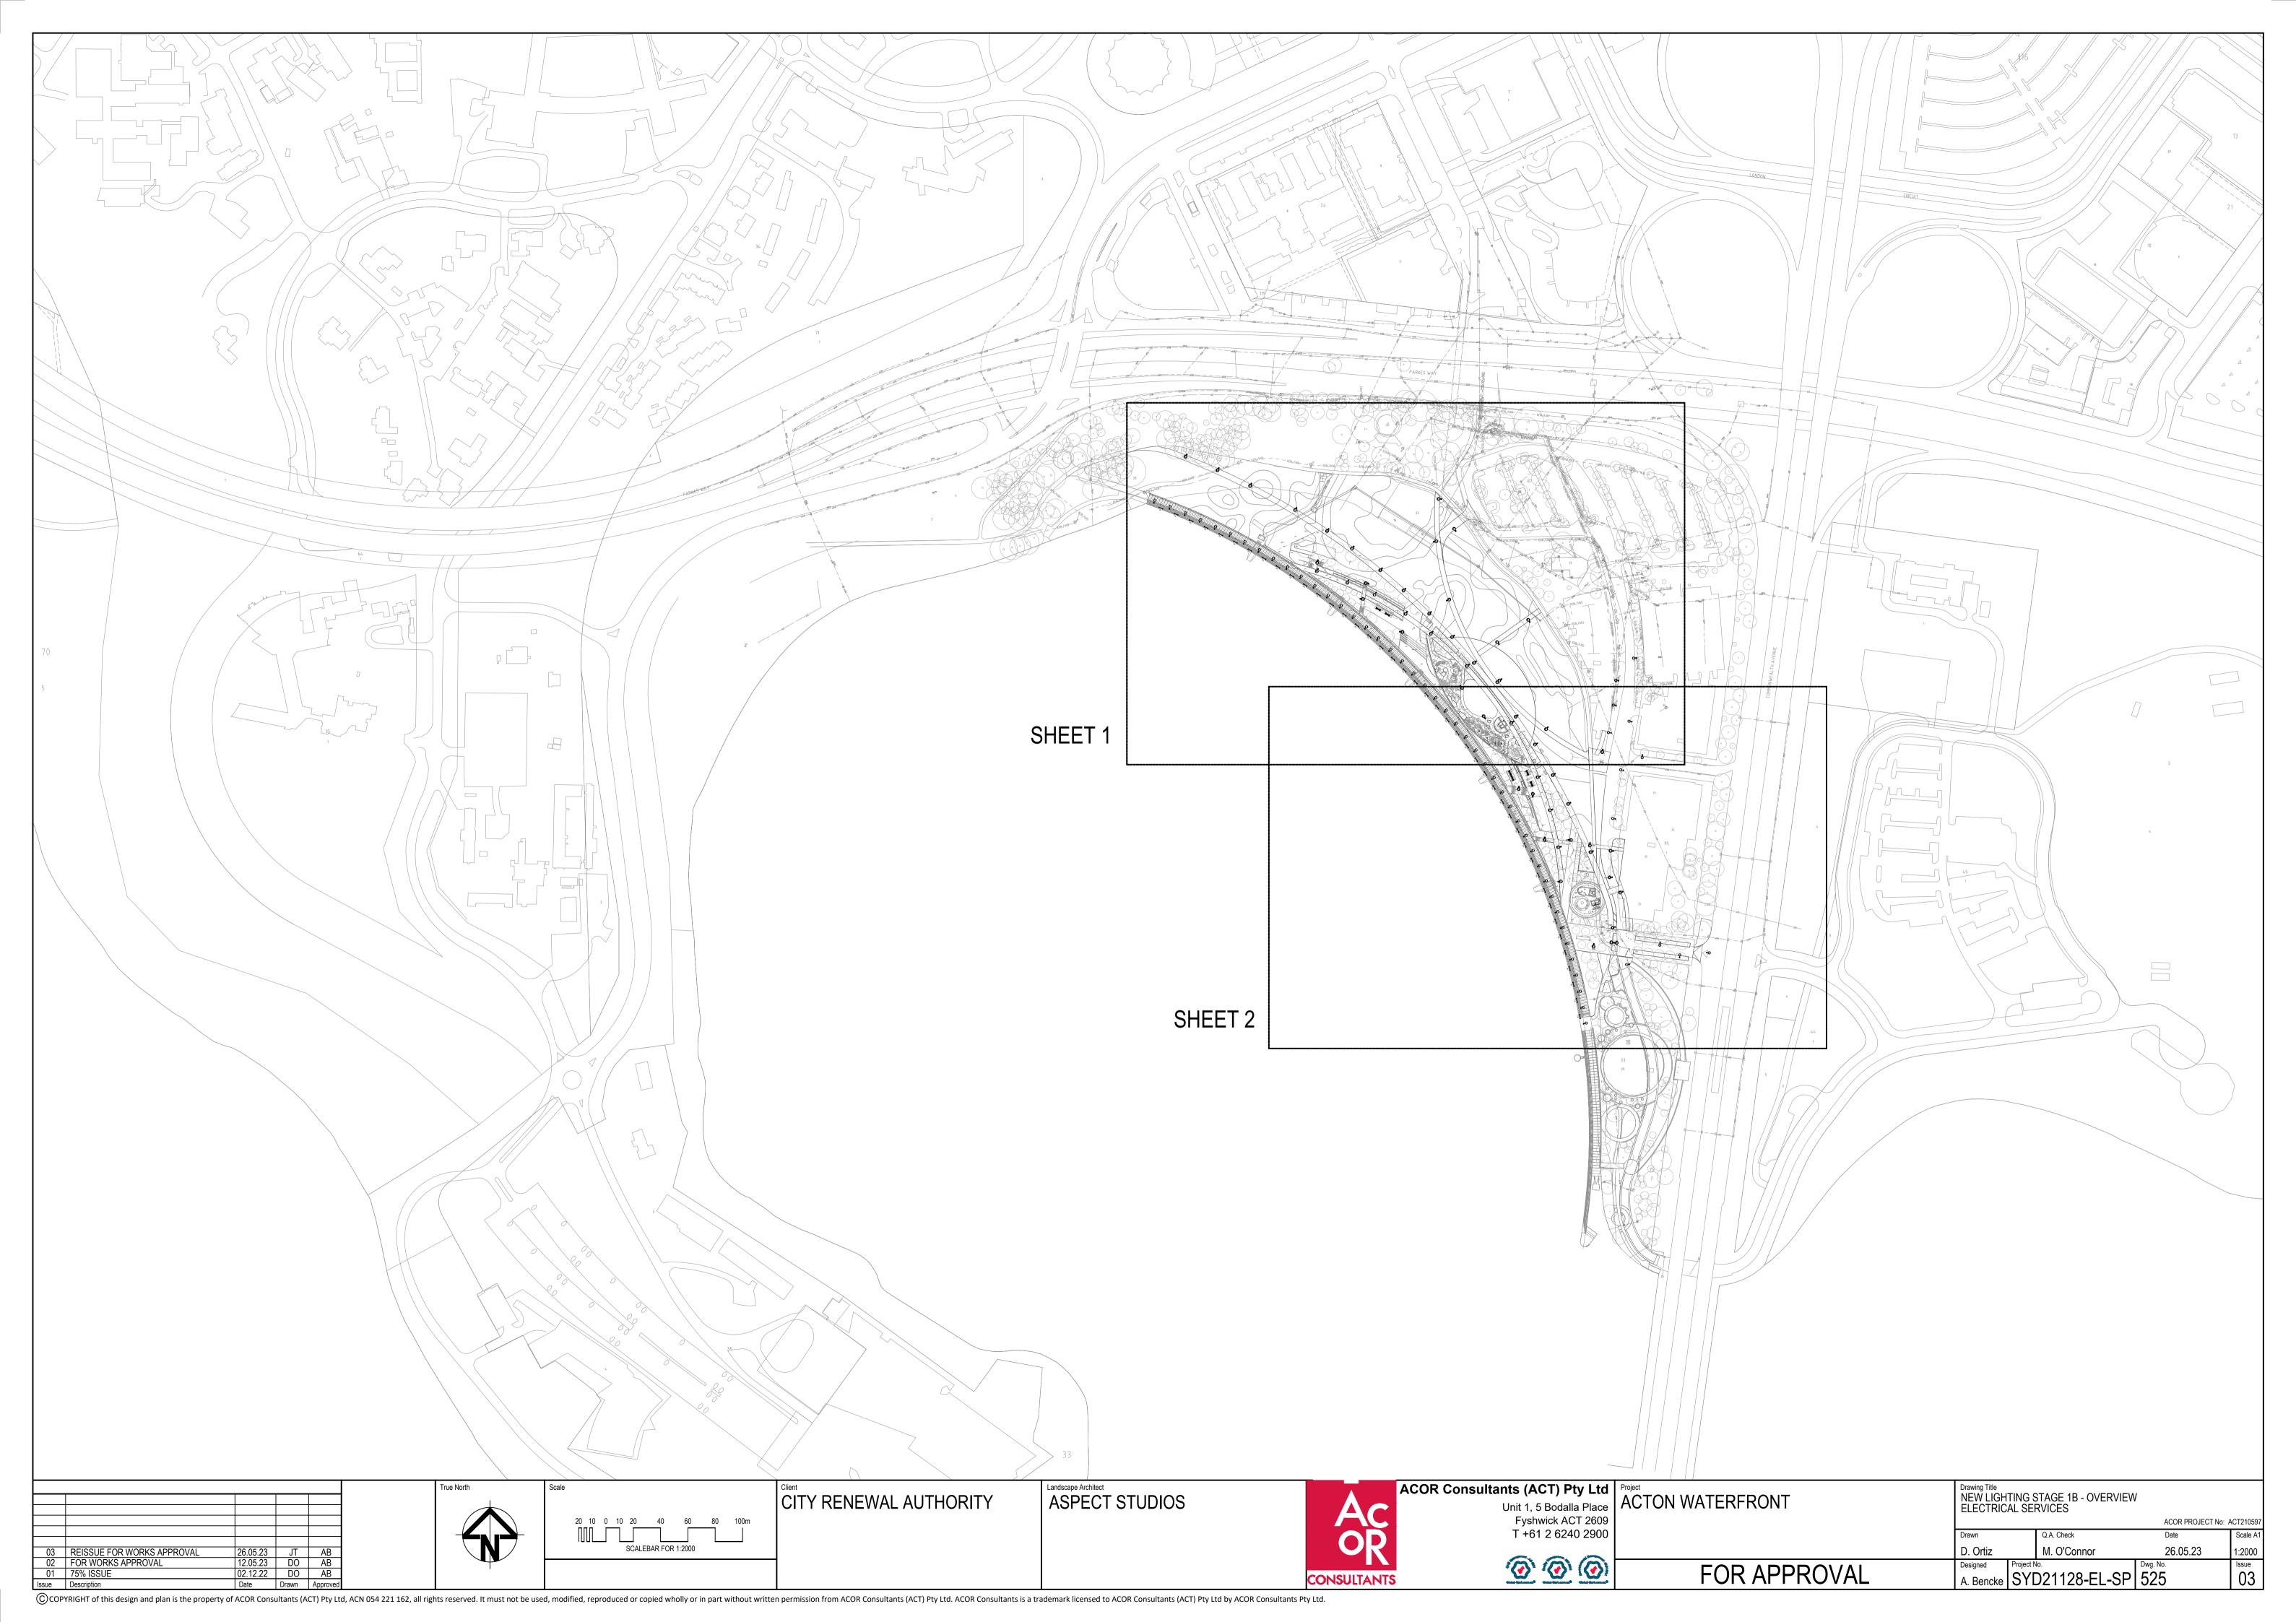
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Fyshwick ACT 2609
T +61 2 6240 2900


Project
ACTON WATERFRONT


Drawing Title
LEGEND
ELECTRICAL & MECHANICAL SERVICES ACOR PROJECT No: ACT210597 D. Ortiz 12.05.23 Designed Project No.
A. Bencke SYD21128-EL-SP 501 FOR APPROVAL


02 FOR WORKS APPROVAL 01 75% ISSUE



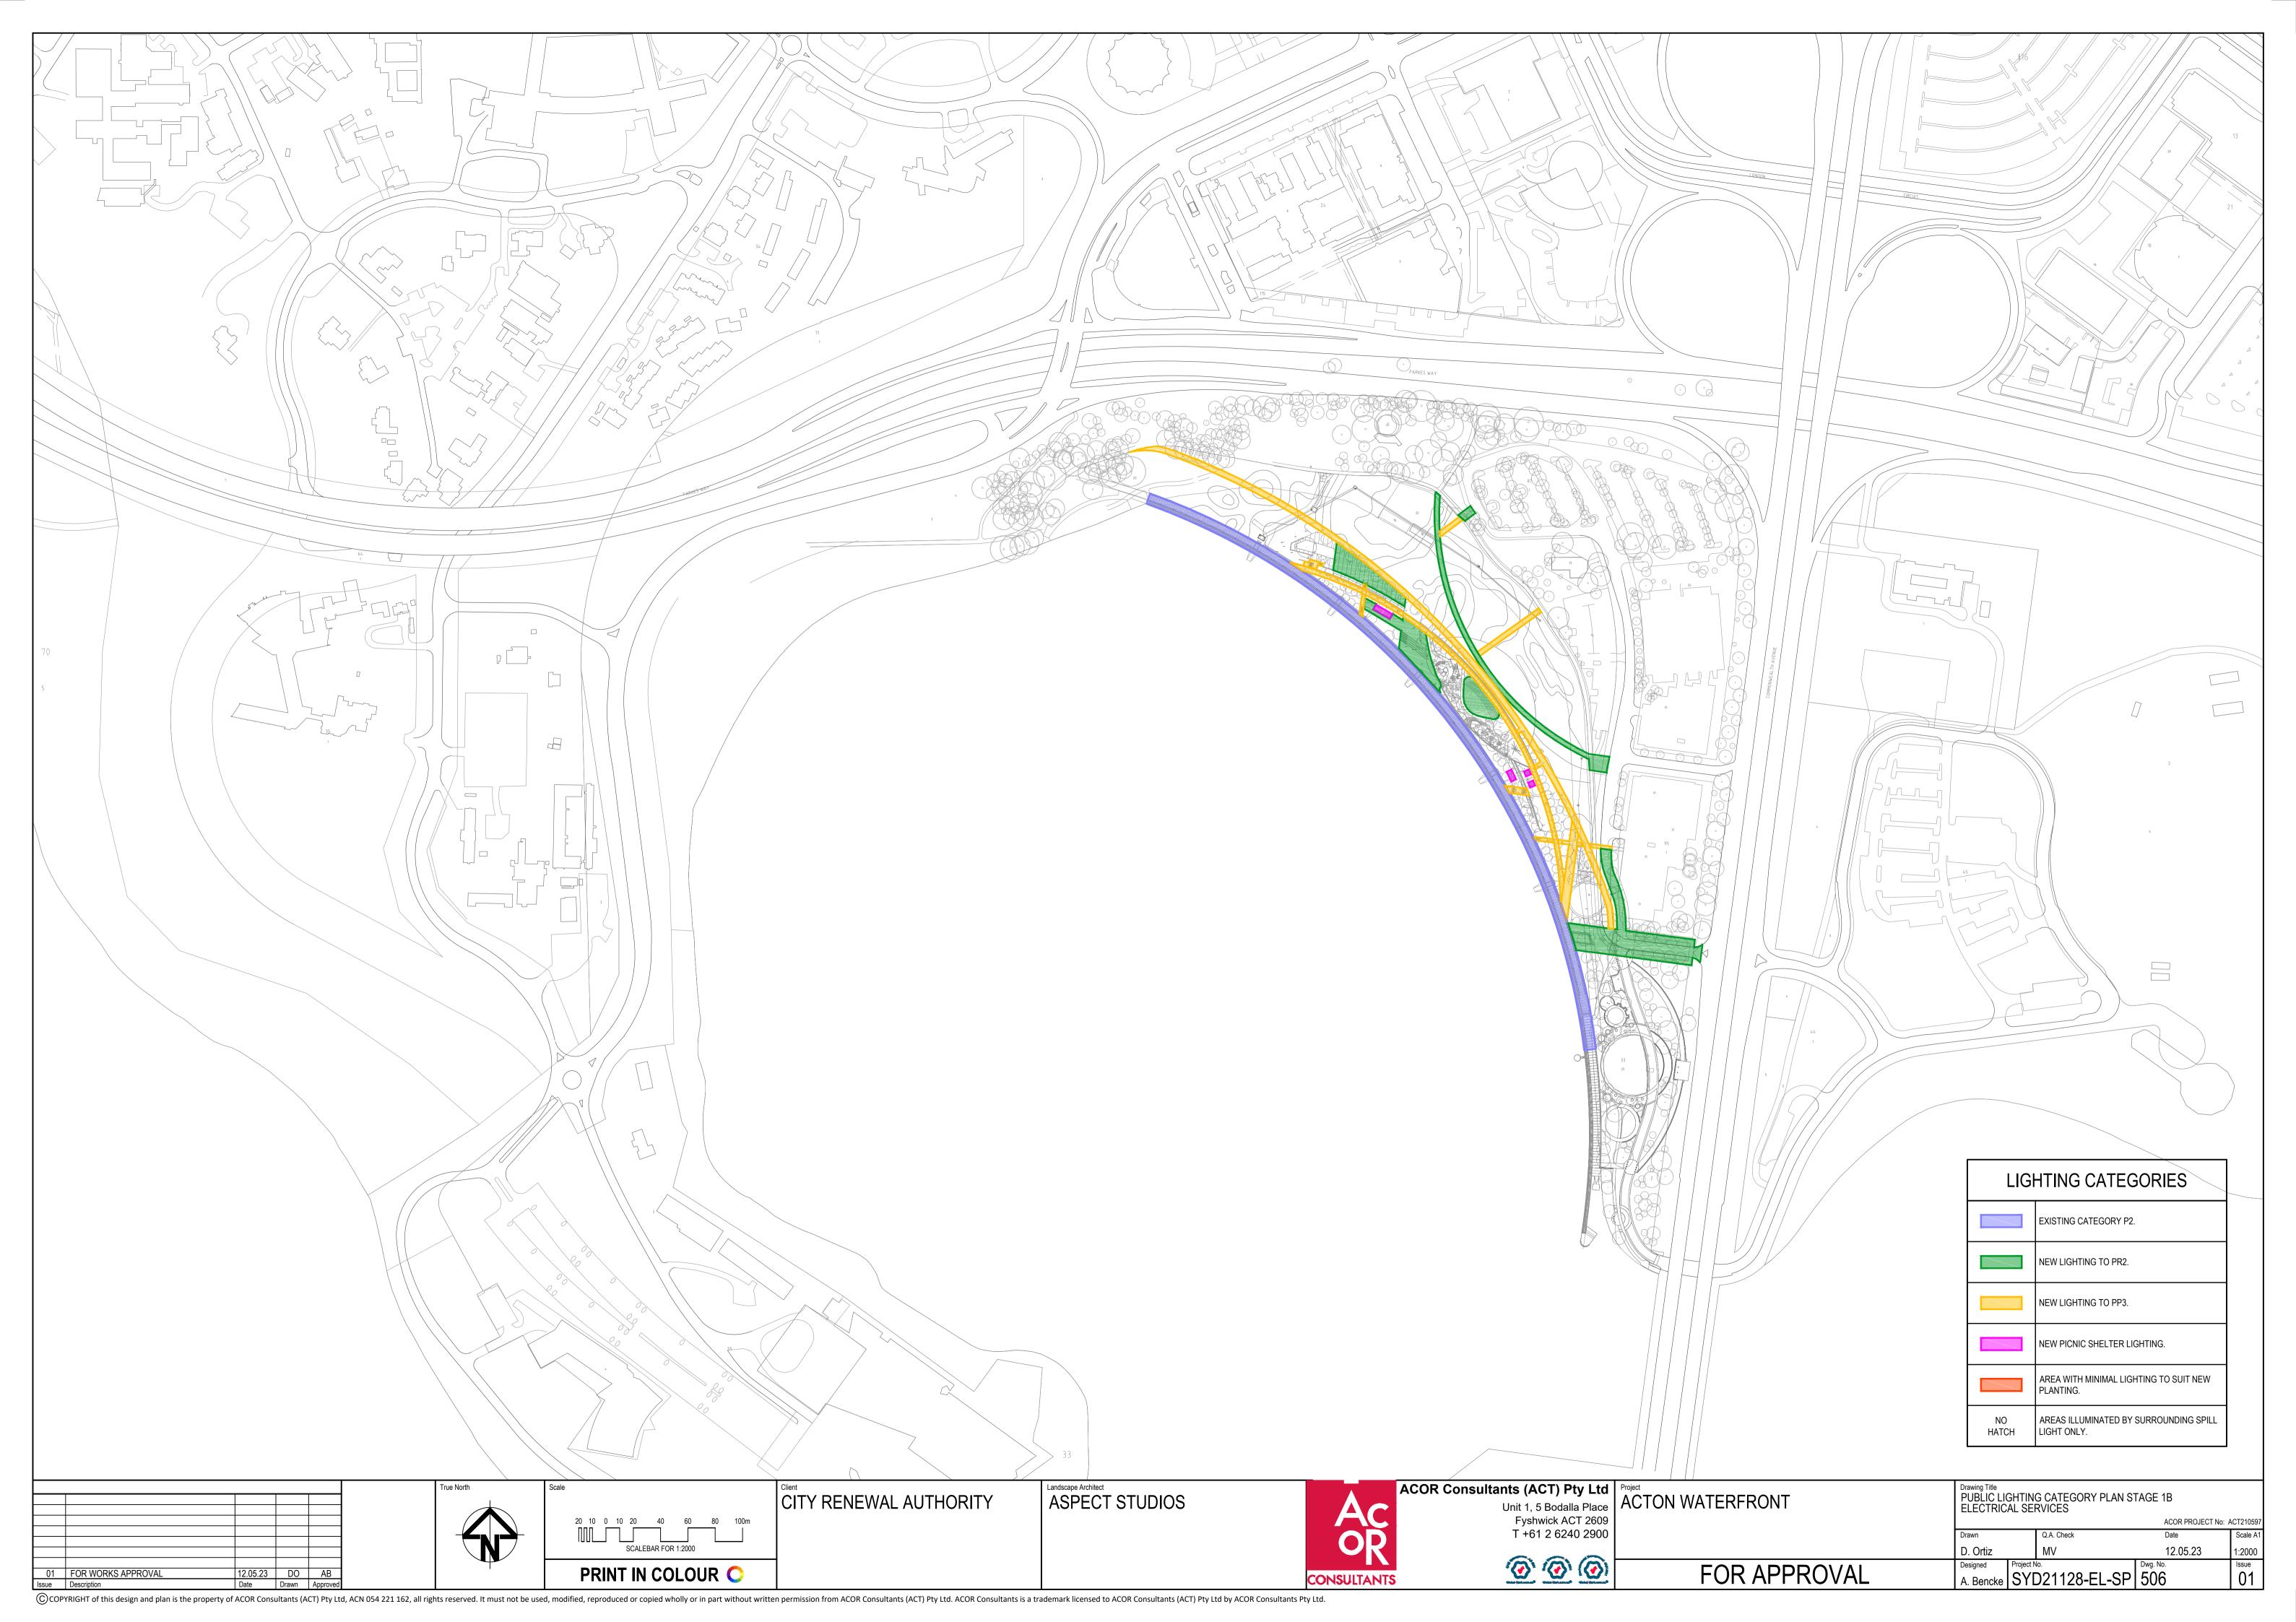

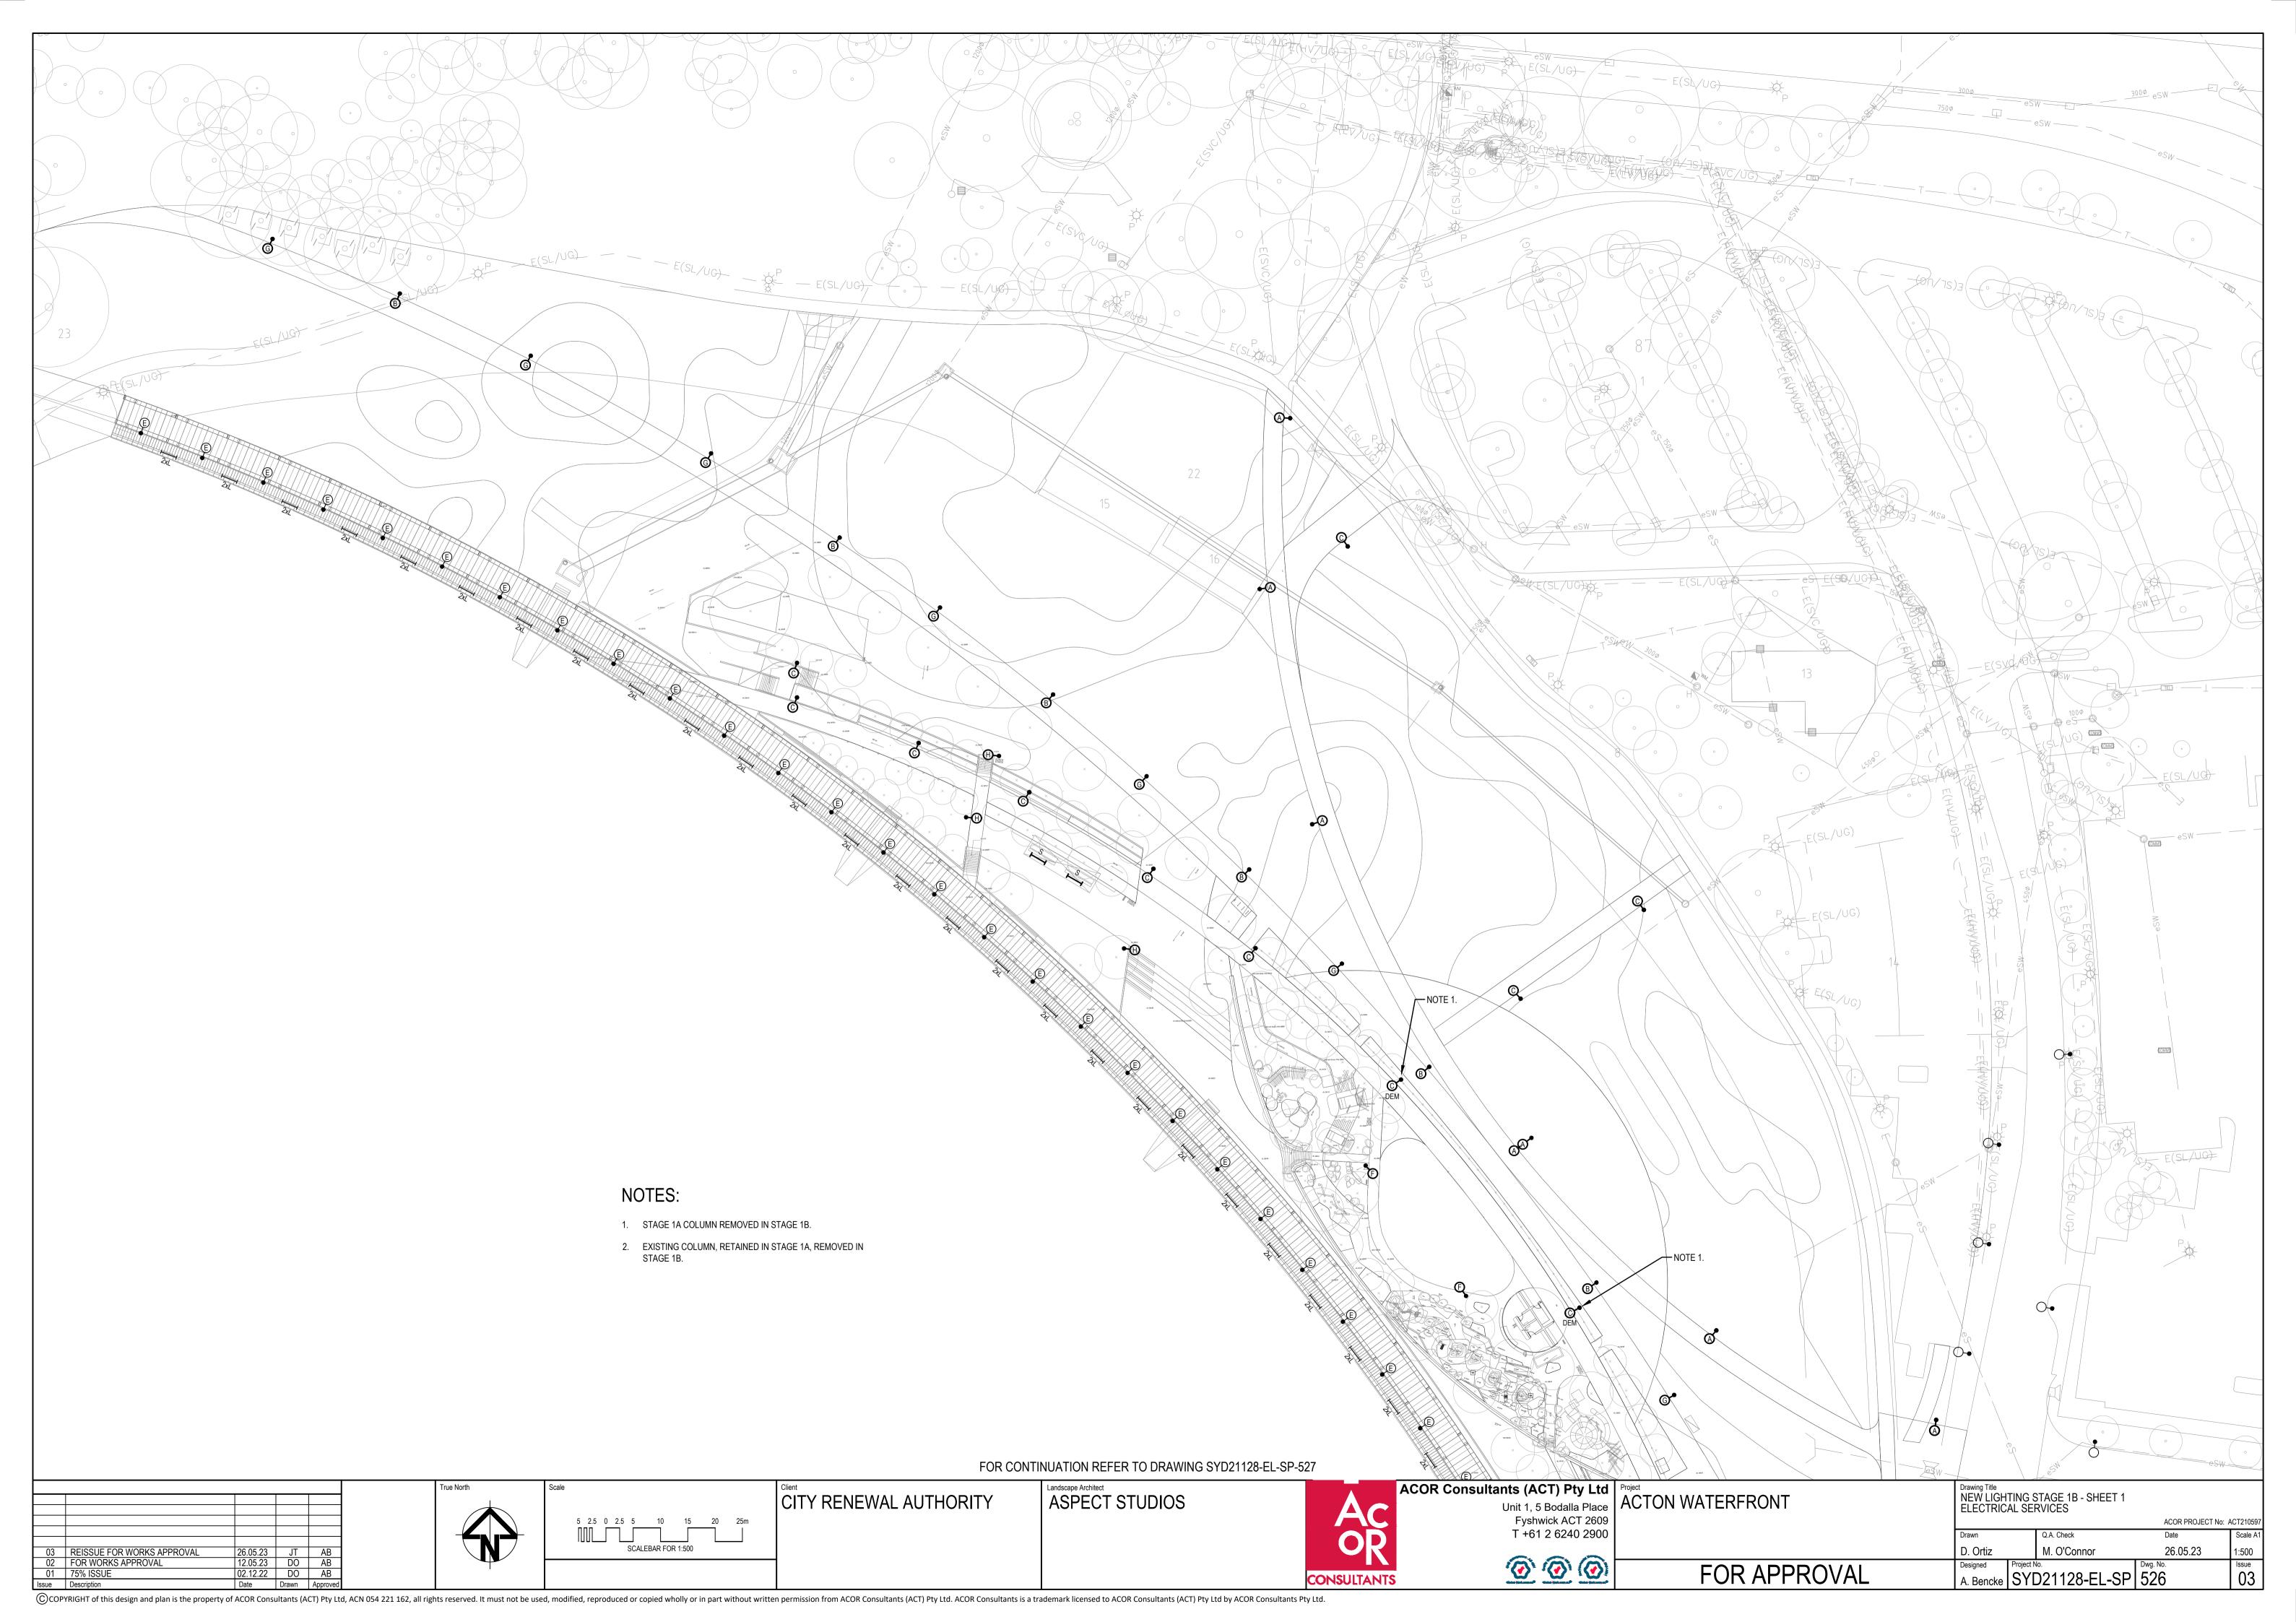


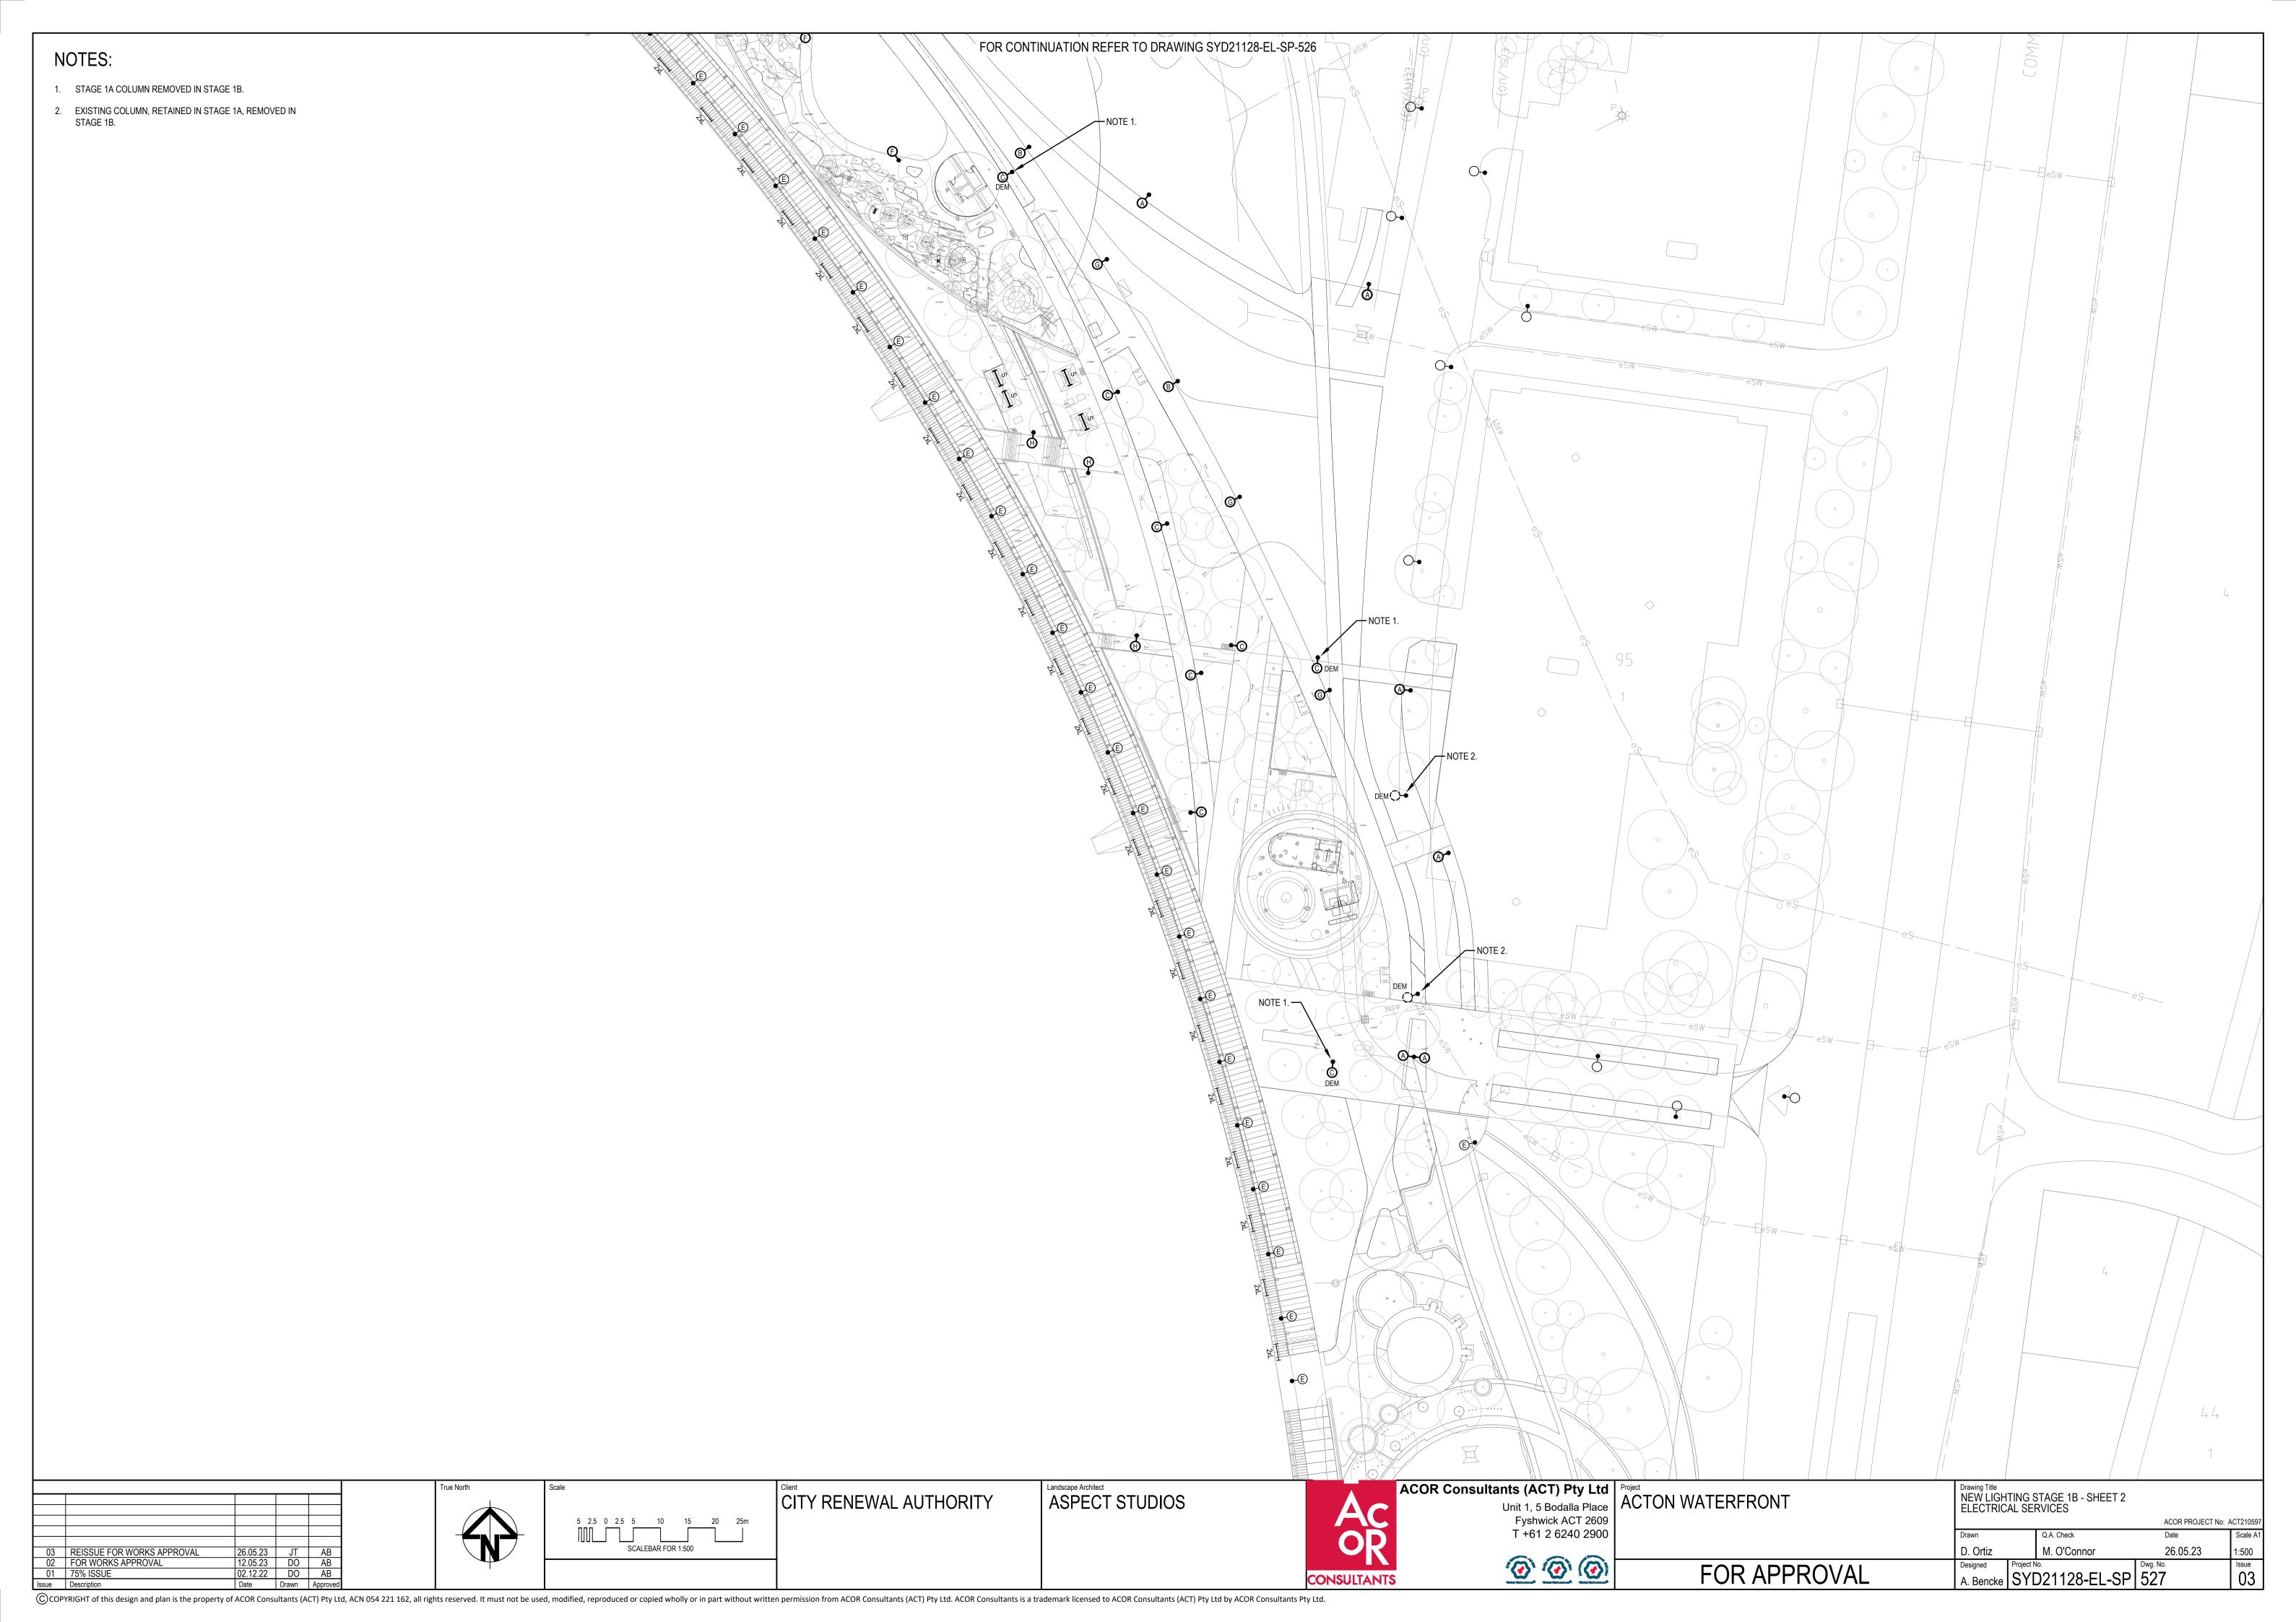

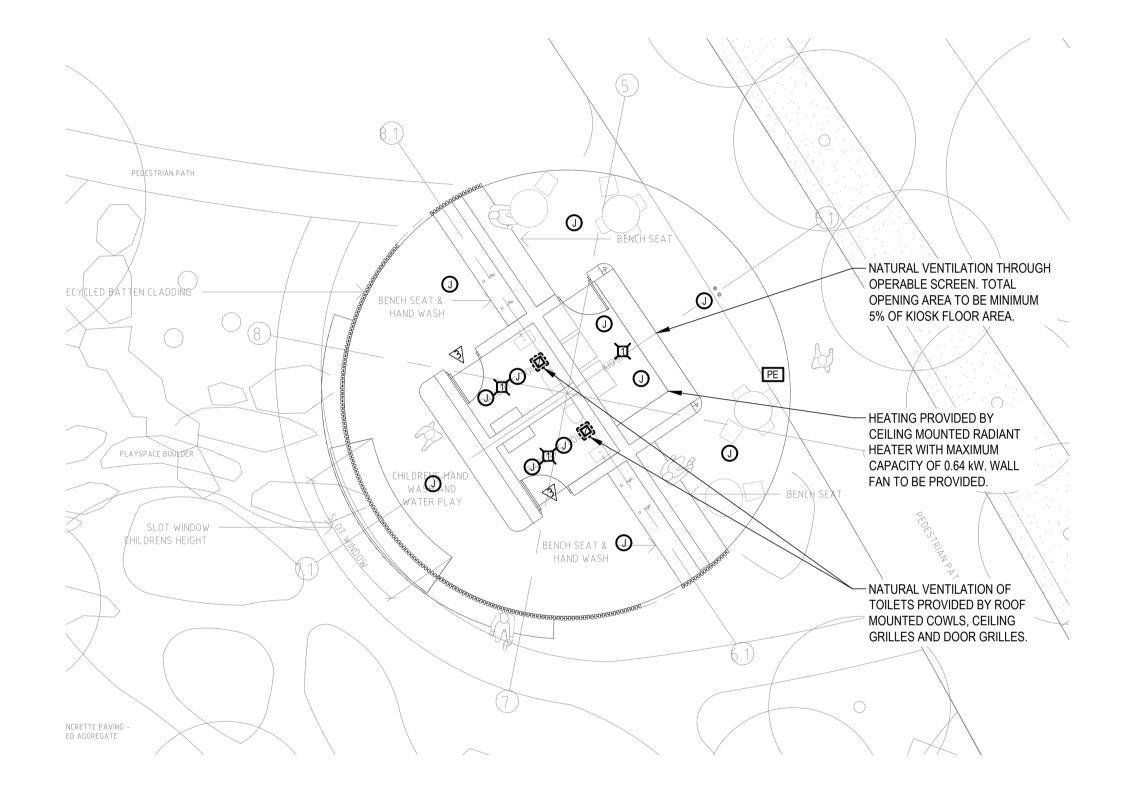


DETAIL 1 - PLAY PAVILION
LIGHTING & MECHANICAL LAYOUT
SCALE 1:100

1
941

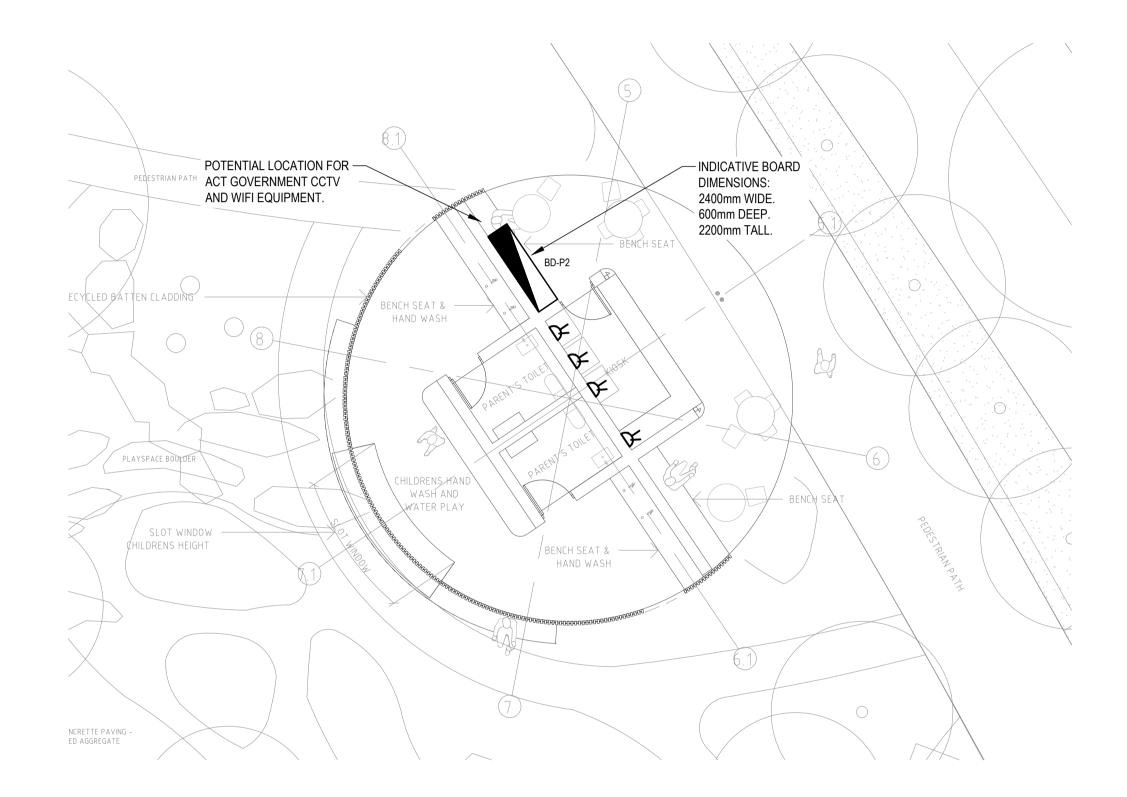


DETAIL 1 - PLAY PAVILION
POWER LAYOUT
SCALE 1:100

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CITY RENEWAL AUTHORITY

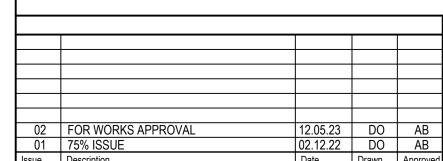ASPECT STUDIOS

COR Consultants (ACT) Pty Ltd	
Unit 1, 5 Bodalla Place	۱,
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T +61 2 6240 2900	

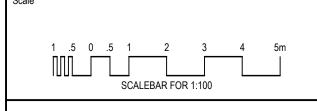
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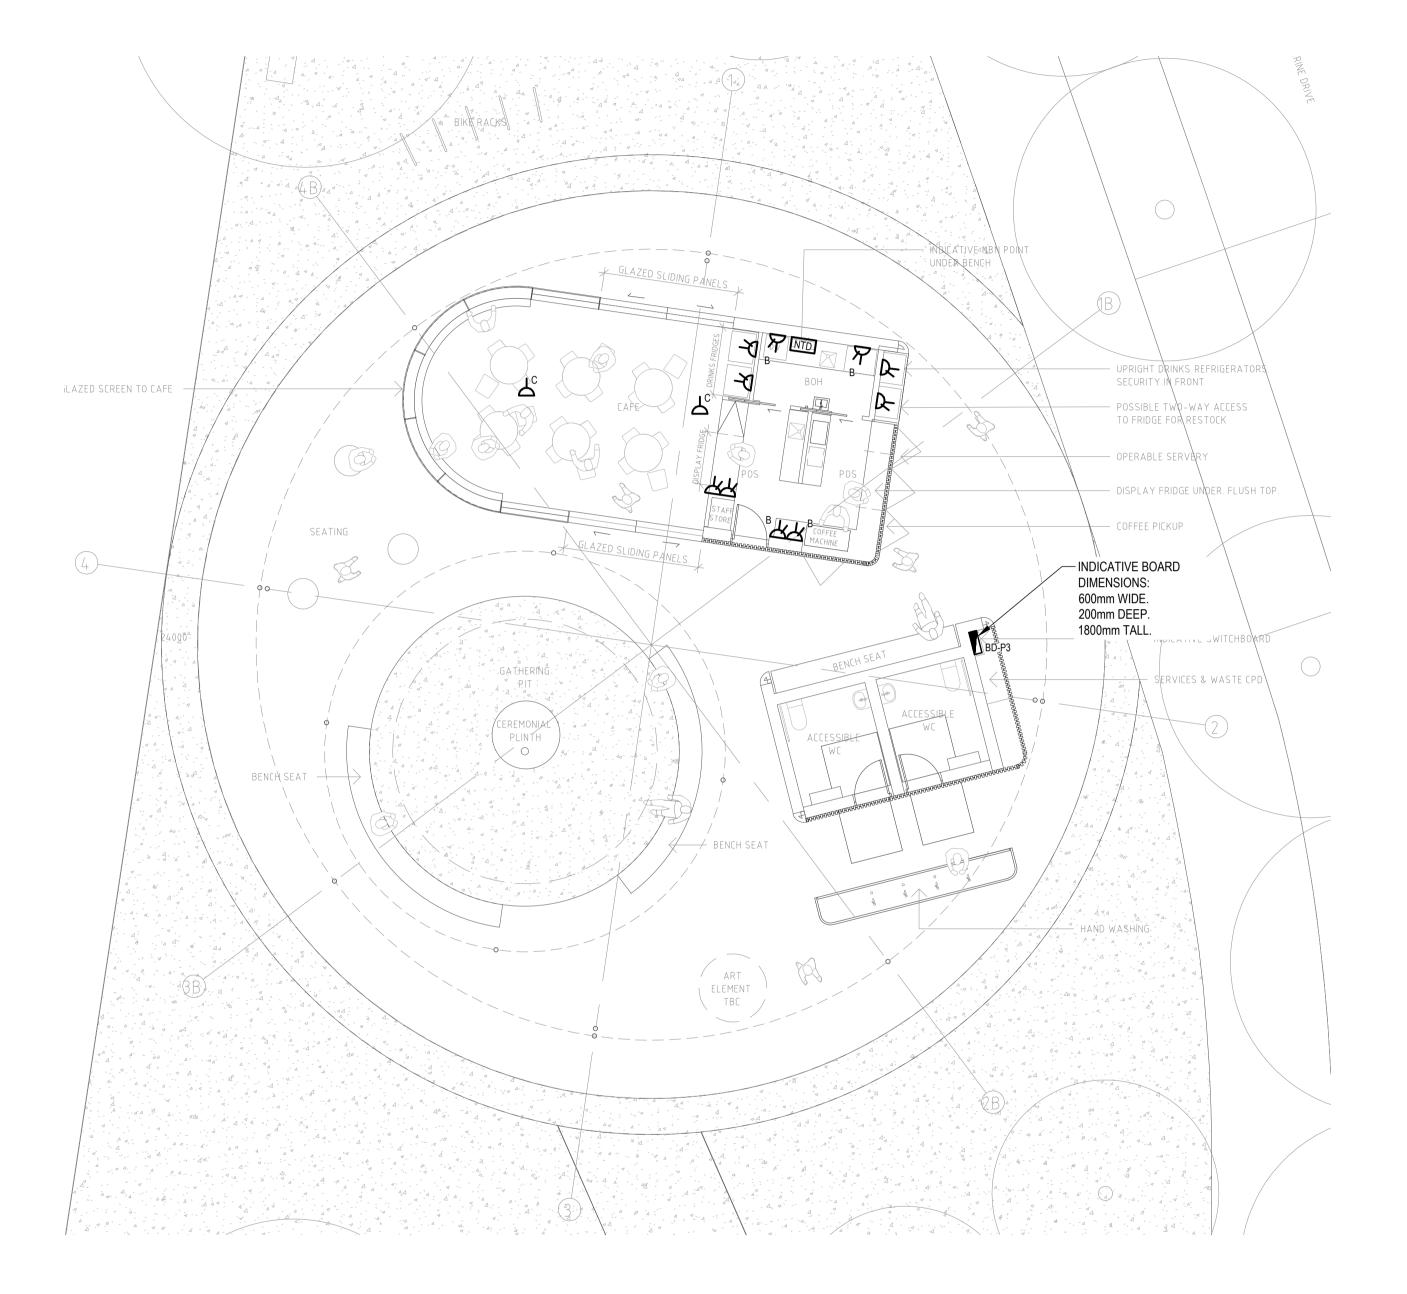
y Ltd	ACTON WATERFRONT	
Place	ACTON WATERFRONT	
7 2609 2900		
2900		

FOR APPROVAL

DETAIL 1 - PLAY PAVILION LIGHTING, POWER & MECHANICAL LAYOUTS							
			ACOR PROJECT No: A	ACT210			
Drawn		Q.A. Check	Date	Scale			
D. Ortiz		MV	12.05.23	1:10			
Designed	Project N	lo.	Dwg. No.	Issue			
A. Bencke	SYE	D21128-EL-SP	951	02			


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DETAIL 2 - ARRIVAL PAVILION LIGHTING & MECHANICAL LAYOUT (2) DETAIL 2 - ARRIVAL PAVILION **POWER LAYOUT** 942 SCALE 1:100

02 FOR WORKS APPROVAL

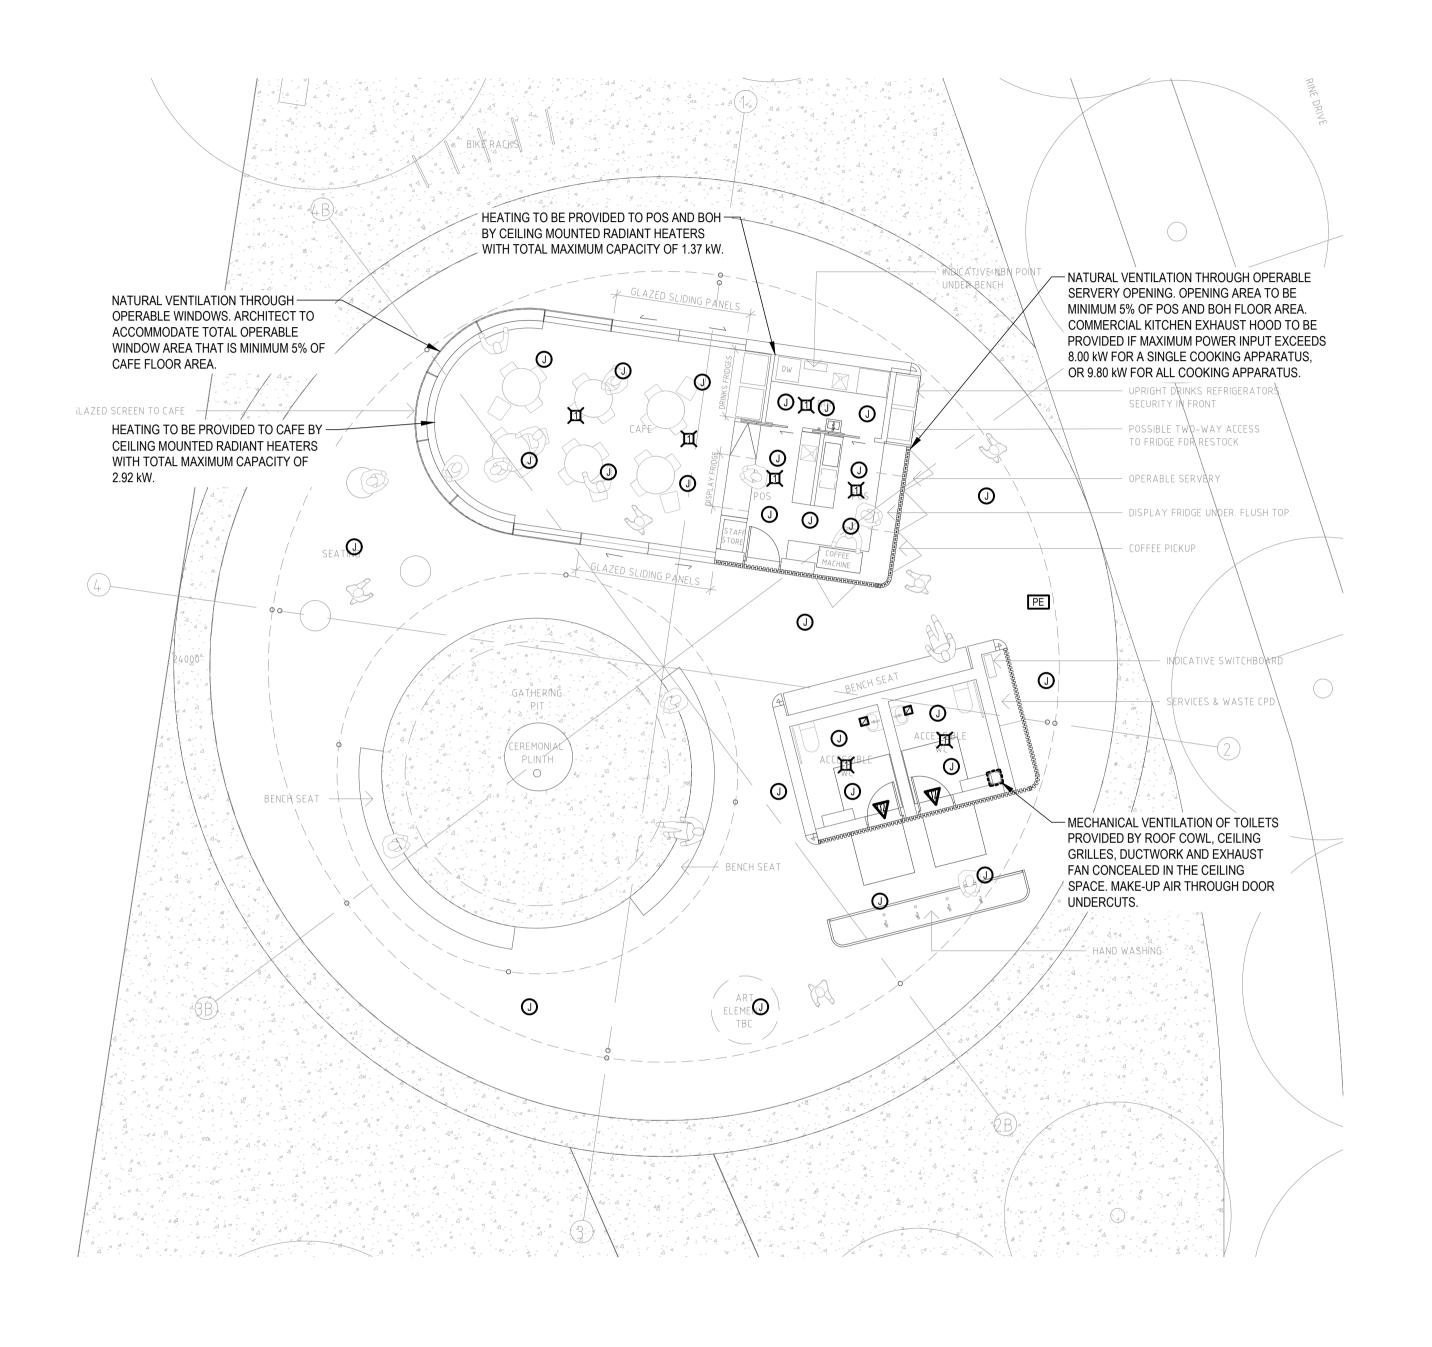

CITY RENEWAL AUTHORITY

ASPECT STUDIOS

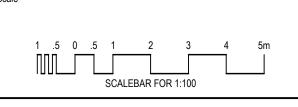Fyshwick ACT 2609 T +61 2 6240 2900

ACOR Consultants (ACT) Pty Ltd

Unit 1, 5 Bodalla Place

Project
ACTON WATERFRONT

FOR APPROVAL

Drawing Title
DETAIL 2 - ARRIVAL PAVILION
LIGHTING, POWER & MECHANICAL LAYOUTS ACOR PROJECT No: ACT210597 D. Ortiz 12.05.23

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					LUN	IINAIRES				
SYMBOL	LIGHT SOURCE WATTAGE LUMENS	COLOUR TEMP (CRI)	MOUNTING STYLE (IP)	OPTIC	COLOUR	CONTROL	STATU MAKE AND MODE			ADDITIONAL REQUIREMENTS
Ç ^{DEM}	-	-	-	-	-	-	EXISTING STREETLIGHT TO BE REMOVED		D	-
Ŷ	-	-	-	-	-	-	EXISTING STREETLI	IGHT TO REMAIN		-
E •	LED 72W	4000K	MOUNTED ON 6m COLUMN	S60	-	-	EXISTI WE-EF VFL540			-
2xL	LED 6W	3000K	CONCRETE RECESSED IP68	120° WALL WASH	-	-	EXISTI DIGILIN TAIP <i>i</i>			-
P	LED 72W 7,550lm	4000K	MOUNTED ON 9m COLUMN WITH 3m OUTREACH ARM	R65	GREY ALUMINIUM	PE CELL AND NEMA BASE	NEW WE-EF VFL			COLUMN TYPE SHALL BE MULTIPOLE. DEM = DENOTES IN STALLED IN ONE STAGE AND REMOVED IN ANOTHER. REFER TO THE NOTES ON THE DRAWINGS.
₿	LED 48W 5,840lm	4000K	MOUNTED ON COLUMN AT 6m AFFL WITH 0.6m OUTREACH ARM	R65	GREY ALUMINIUM	PE CELL AND NEMA BASE	NEW WE-EF VFL			COLUMN TYPE SHALL BE MULTIPOLE.
©	LED 48W 5,840lm	4000K	MOUNTED ON 6m COLUMN	R65	ELECTRO MEDIUM BRONZE	PE CELL AND NEMA BASE		NEW WE-EF VFL540-SE		COLUMN TYPE SHALL BE TAPERED ROUND, WITH RAG BOLT ASSEMBLY, CUSTOM TOP AND COLOUR ELECTRO MEDIUM BRONZE TO MATCH HENRY ROLAND PARK COLUMNS. DEM = DENOTES IN STALLED IN ONE STAGE AND REMOVED IN ANOTHER. REFER TO THE NOTES ON THE DRAWINGS.
0	LED	4000K	HANDRAIL LIGHTING	ASYMMETRICAL	-	-	NEW HANDRAIL LU			-
P	LED 24W	4000K	MOUNTED ON 6m COLUMN	A60	ELECTRO MEDIUM BRONZE	PE CELL AND NEMA BASE	NEW WE-EF VFL			COLUMN TYPE SHALL BE TAPERED ROUND, WITH RAG BOLT ASSEMBLY, CUSTOM TOP AND COLOUR ELECTRO MEDIUM BRONZE TO MATCH HENRY ROLAND PARK COLUMNS.
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0	LED	4000K	SURFACE MOUNTED	ТВС	ТВС	MOTION SENSOR OR PE CELL	NEW DOWNLIGH			-
S	LED 20W 2880lm	4000K	SURFACE MOUNTED (IP67, IK09)	WIDE BEAM	BLACK	MOTION SENSOR	NEW WE-EF VI			-
		LIGHTING)		Р	OWER		CON	IDUITS	S & INGROUND SERVICES
SYMBOL		DESCR	RIPTION	SYMBOL		DESCRIPTION	ON	LINETYPE DENO		SERVICE TYPE
Д	NEW MOTION SE	NSOR.		\forall	SINGLE OR DOUBLE GENERAL PURPOSE POWER OUTLET. EQUAL TO HPM EXCEL LIFE OR CLIPSAL 2000 RANGE. REFER TO STANDARD NOTATIONS ADJACENT LEGEND.			REMOVED		
PE		CONTROL EXTER	RNAL LIGHTING. PE CELL SHALL BE DN SYSTEM.		XISTING MINIPILLA	R TO REMAIN.				LD LIGHT DUTY 100 CONDUIT DIAMETER 2 x QUANTITY OF CONDUITS
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				CC N	I = NEW.		CUBICLE TO REMAIN.	eHV	CONDUIT ORANGE H	TAGE CONDUITS. LOCATIONS SHOWN ARE INDICATIVE ONLY. HDU-PVC ELECTRICAL CONDUIT, SIZE AND QUANTITY AS
				N	I = NEW.	ON OR SWITCHBOA	ARD TO REMAIN.	LV	LOW VOLT	O ON DRAWING. FAGE CONDUITS LOCATIONS SHOWN ARE INDICATIVE ONLY.
				РВ	IEW POWER BOX.			eLV	INDICATED	HDU-PVC ELECTRICAL CONDUIT, SIZE AND QUANTITY AS DON DRAWING. MUNICATIONS CONDUITS.
				WB N	IEW WATERPLAY C	ONTROL BOARD.		— eNBN - — —— eNBN ——	CONDUIT I WHITE PV INDICATED	LOCATIONS SHOWN ARE INDICATIVE ONLY. C COMMUNICATIONS CONDUIT, SIZE AND QUANTITY AS D ON DRAWING.
									WHITE PV	CATIONS CONDUITS. C COMMUNICATIONS CONDUIT, SIZE AND QUANTITY AS D ON DRAWING.
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					IEW NBN NETWORK	DESCRIPTION OF THE PROPERTY OF			X = DENOT D = E =	TES PIT STATUS. EXISTING PIT TO BE DEMOLISHED. EXISTING PIT TO REMAIN. NEW PIT.
				l l		CATIONS CABINET	TO REMAIN.			= RELOCATED EXISTING PIT.
				COM N	I = NEW.					

NOTATIONS FOR POWER & COMMUNICATIONS

NOTATION	DESCRIPTION
15A	15Amp SINGLE PHASE OUTLET.
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INSTALL THE OUTLETS AT 350 AFFL TO CENTERLINE OF OUTLET UNLESS SHOWN OTHERWISE.

MECHANICAL DESCRIPTION SYMBOL ROOF MOUNTED EXHAUST FAN 30mm DOOR UNDERCUT 600x450 DOOR GRILLE 200x200 EXHAUST GRILLE

ASPECT STUDIOS

CITY RENEWAL AUTHORITY

GENERAL NOTE:

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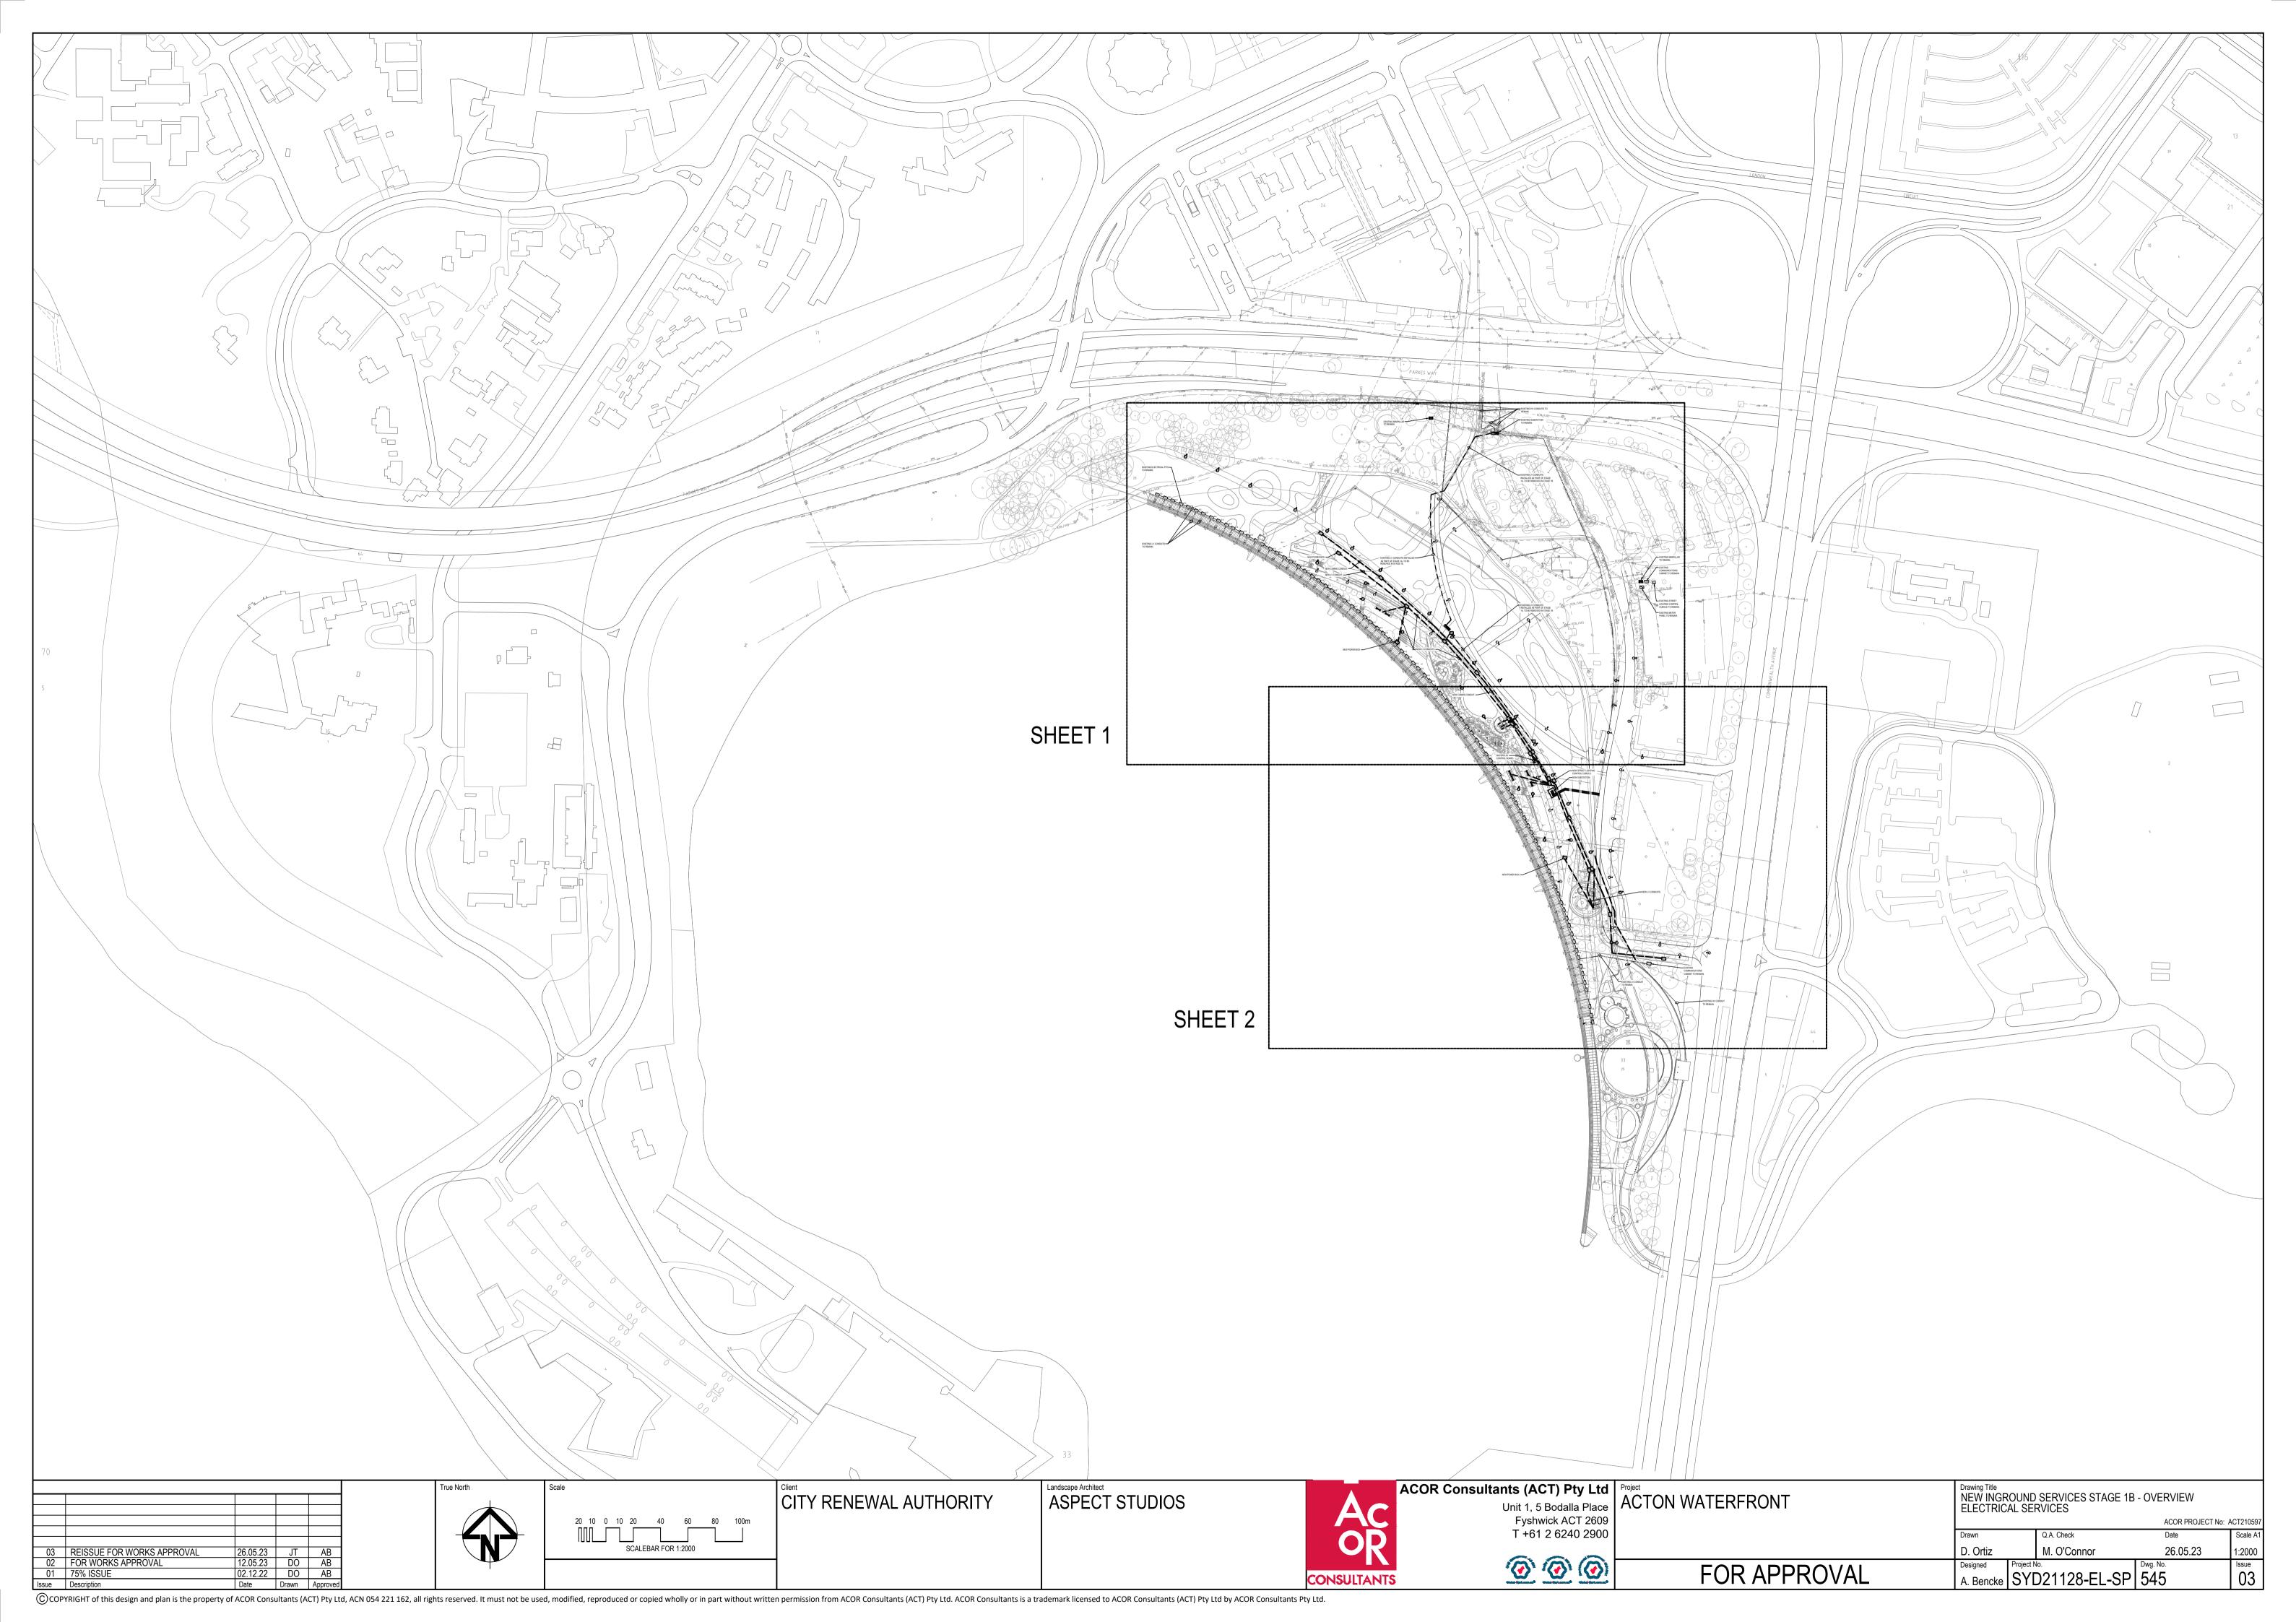
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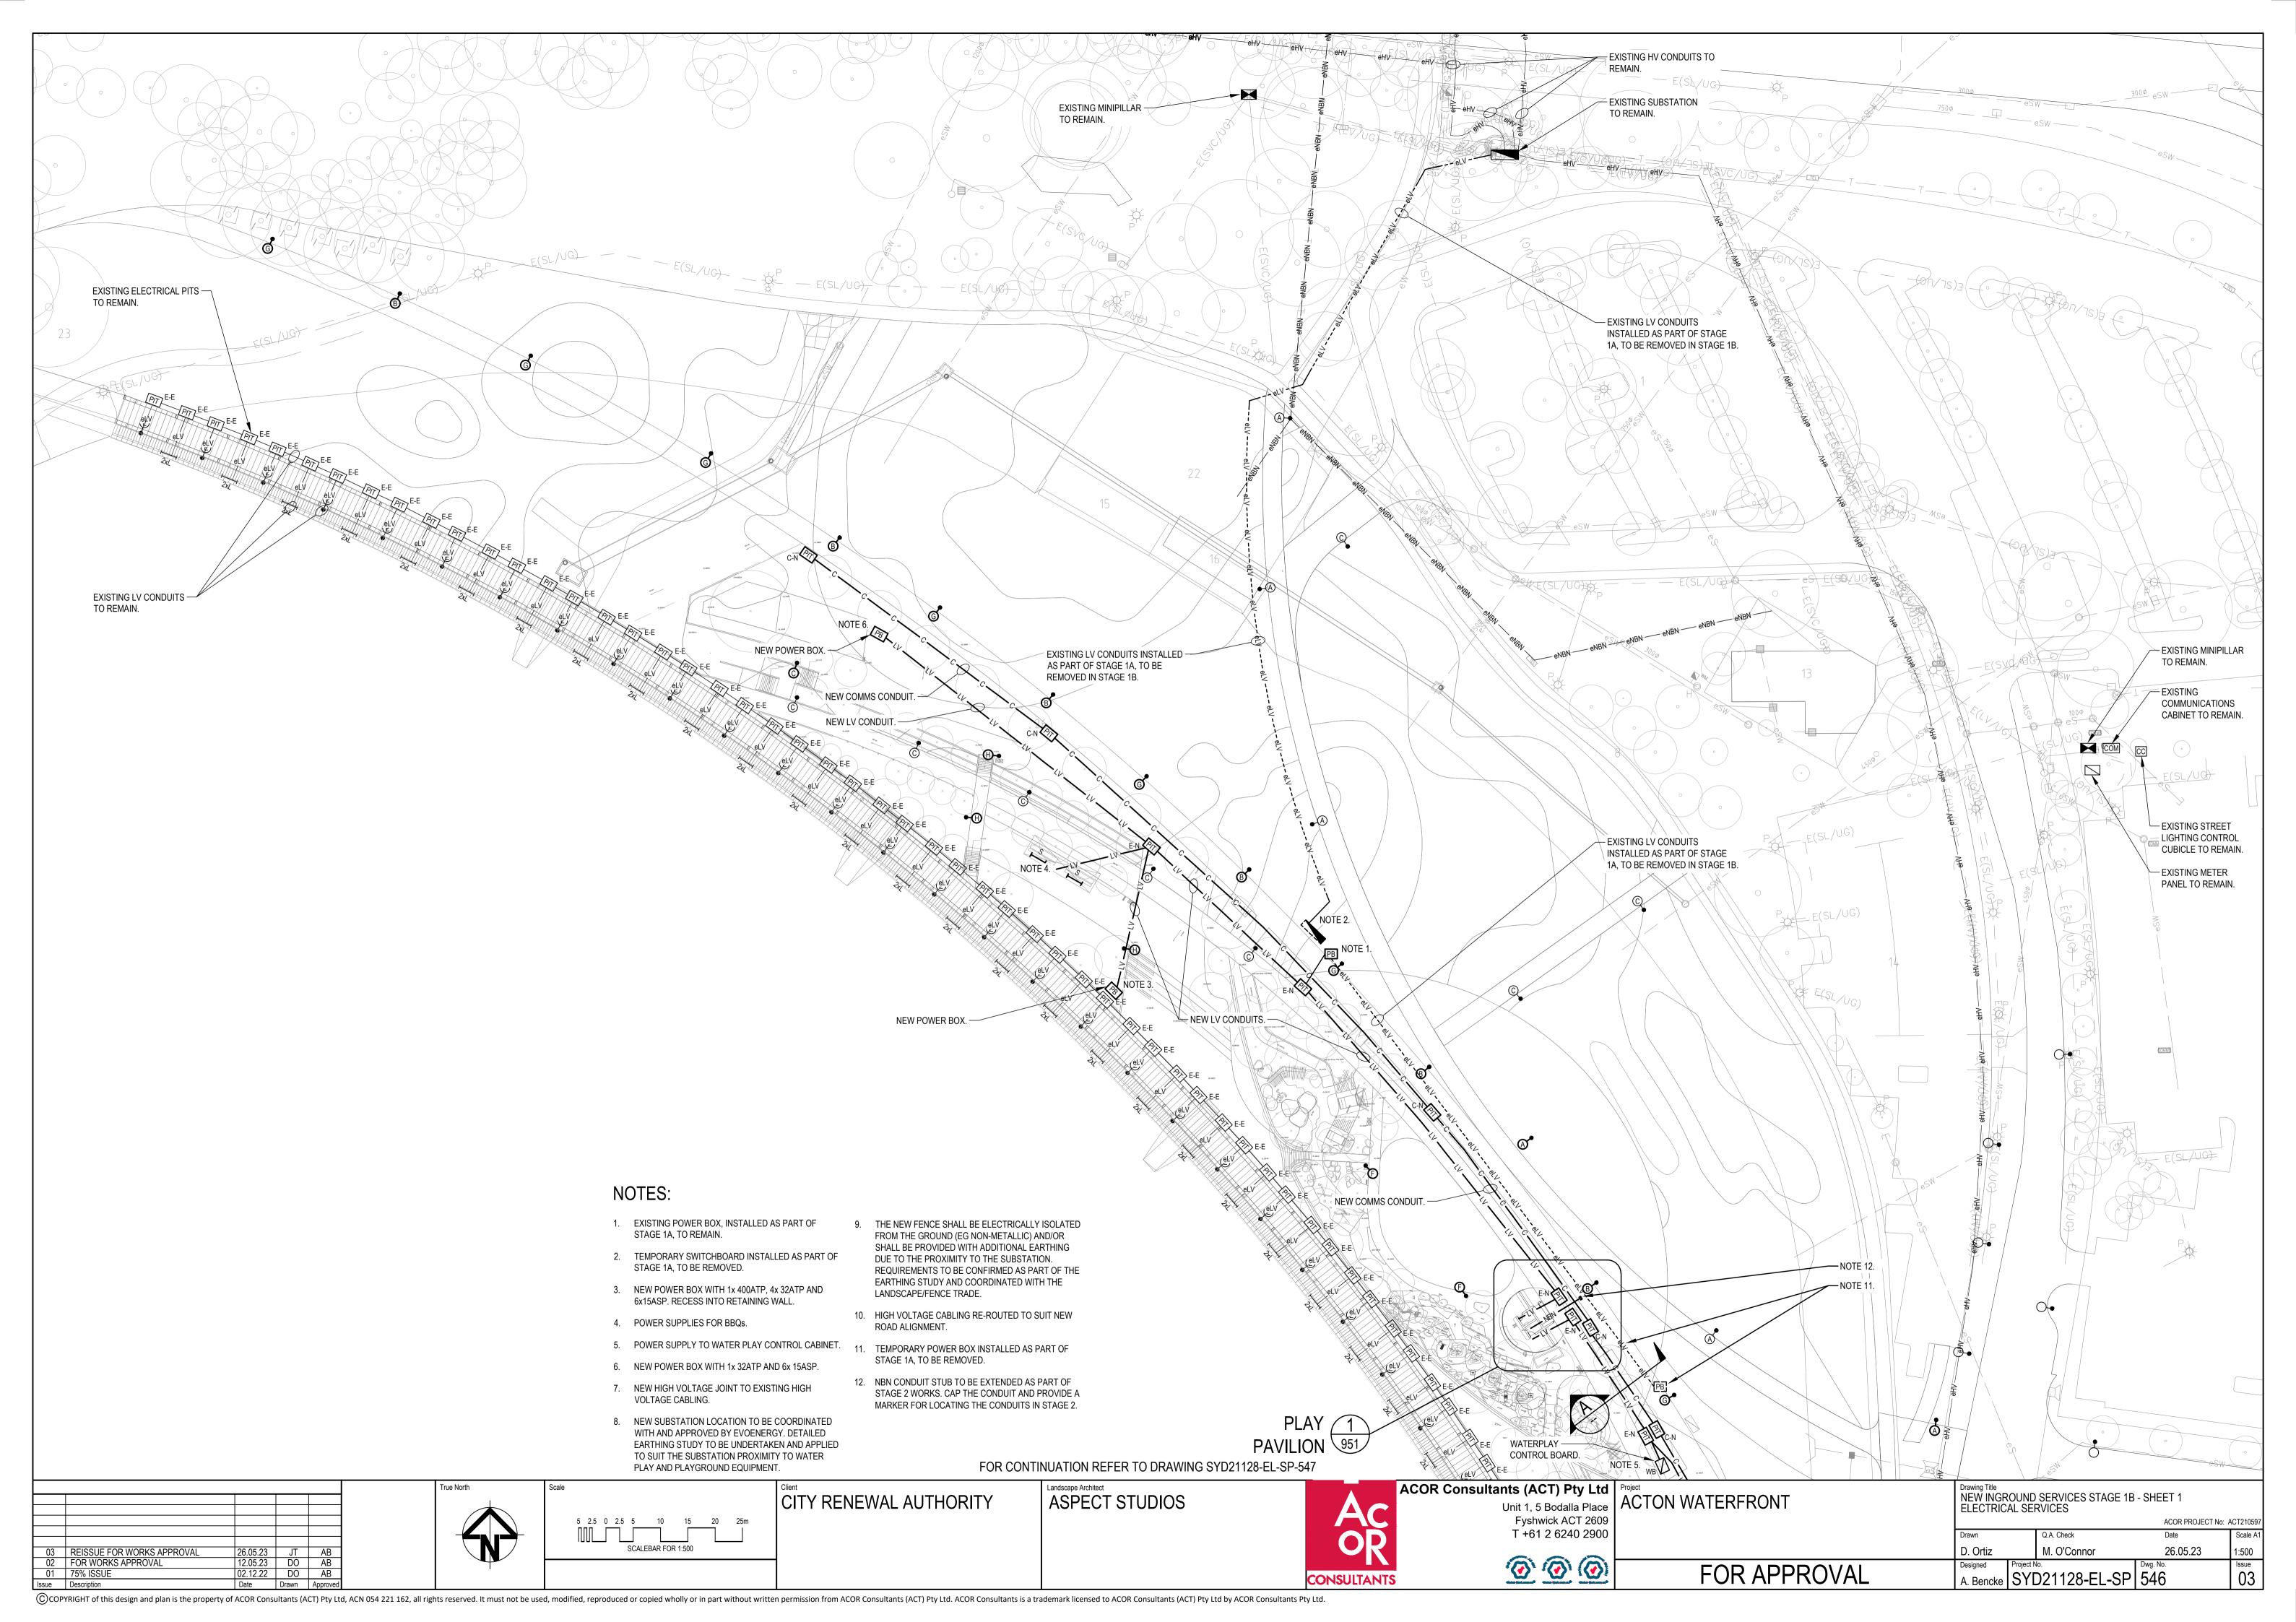
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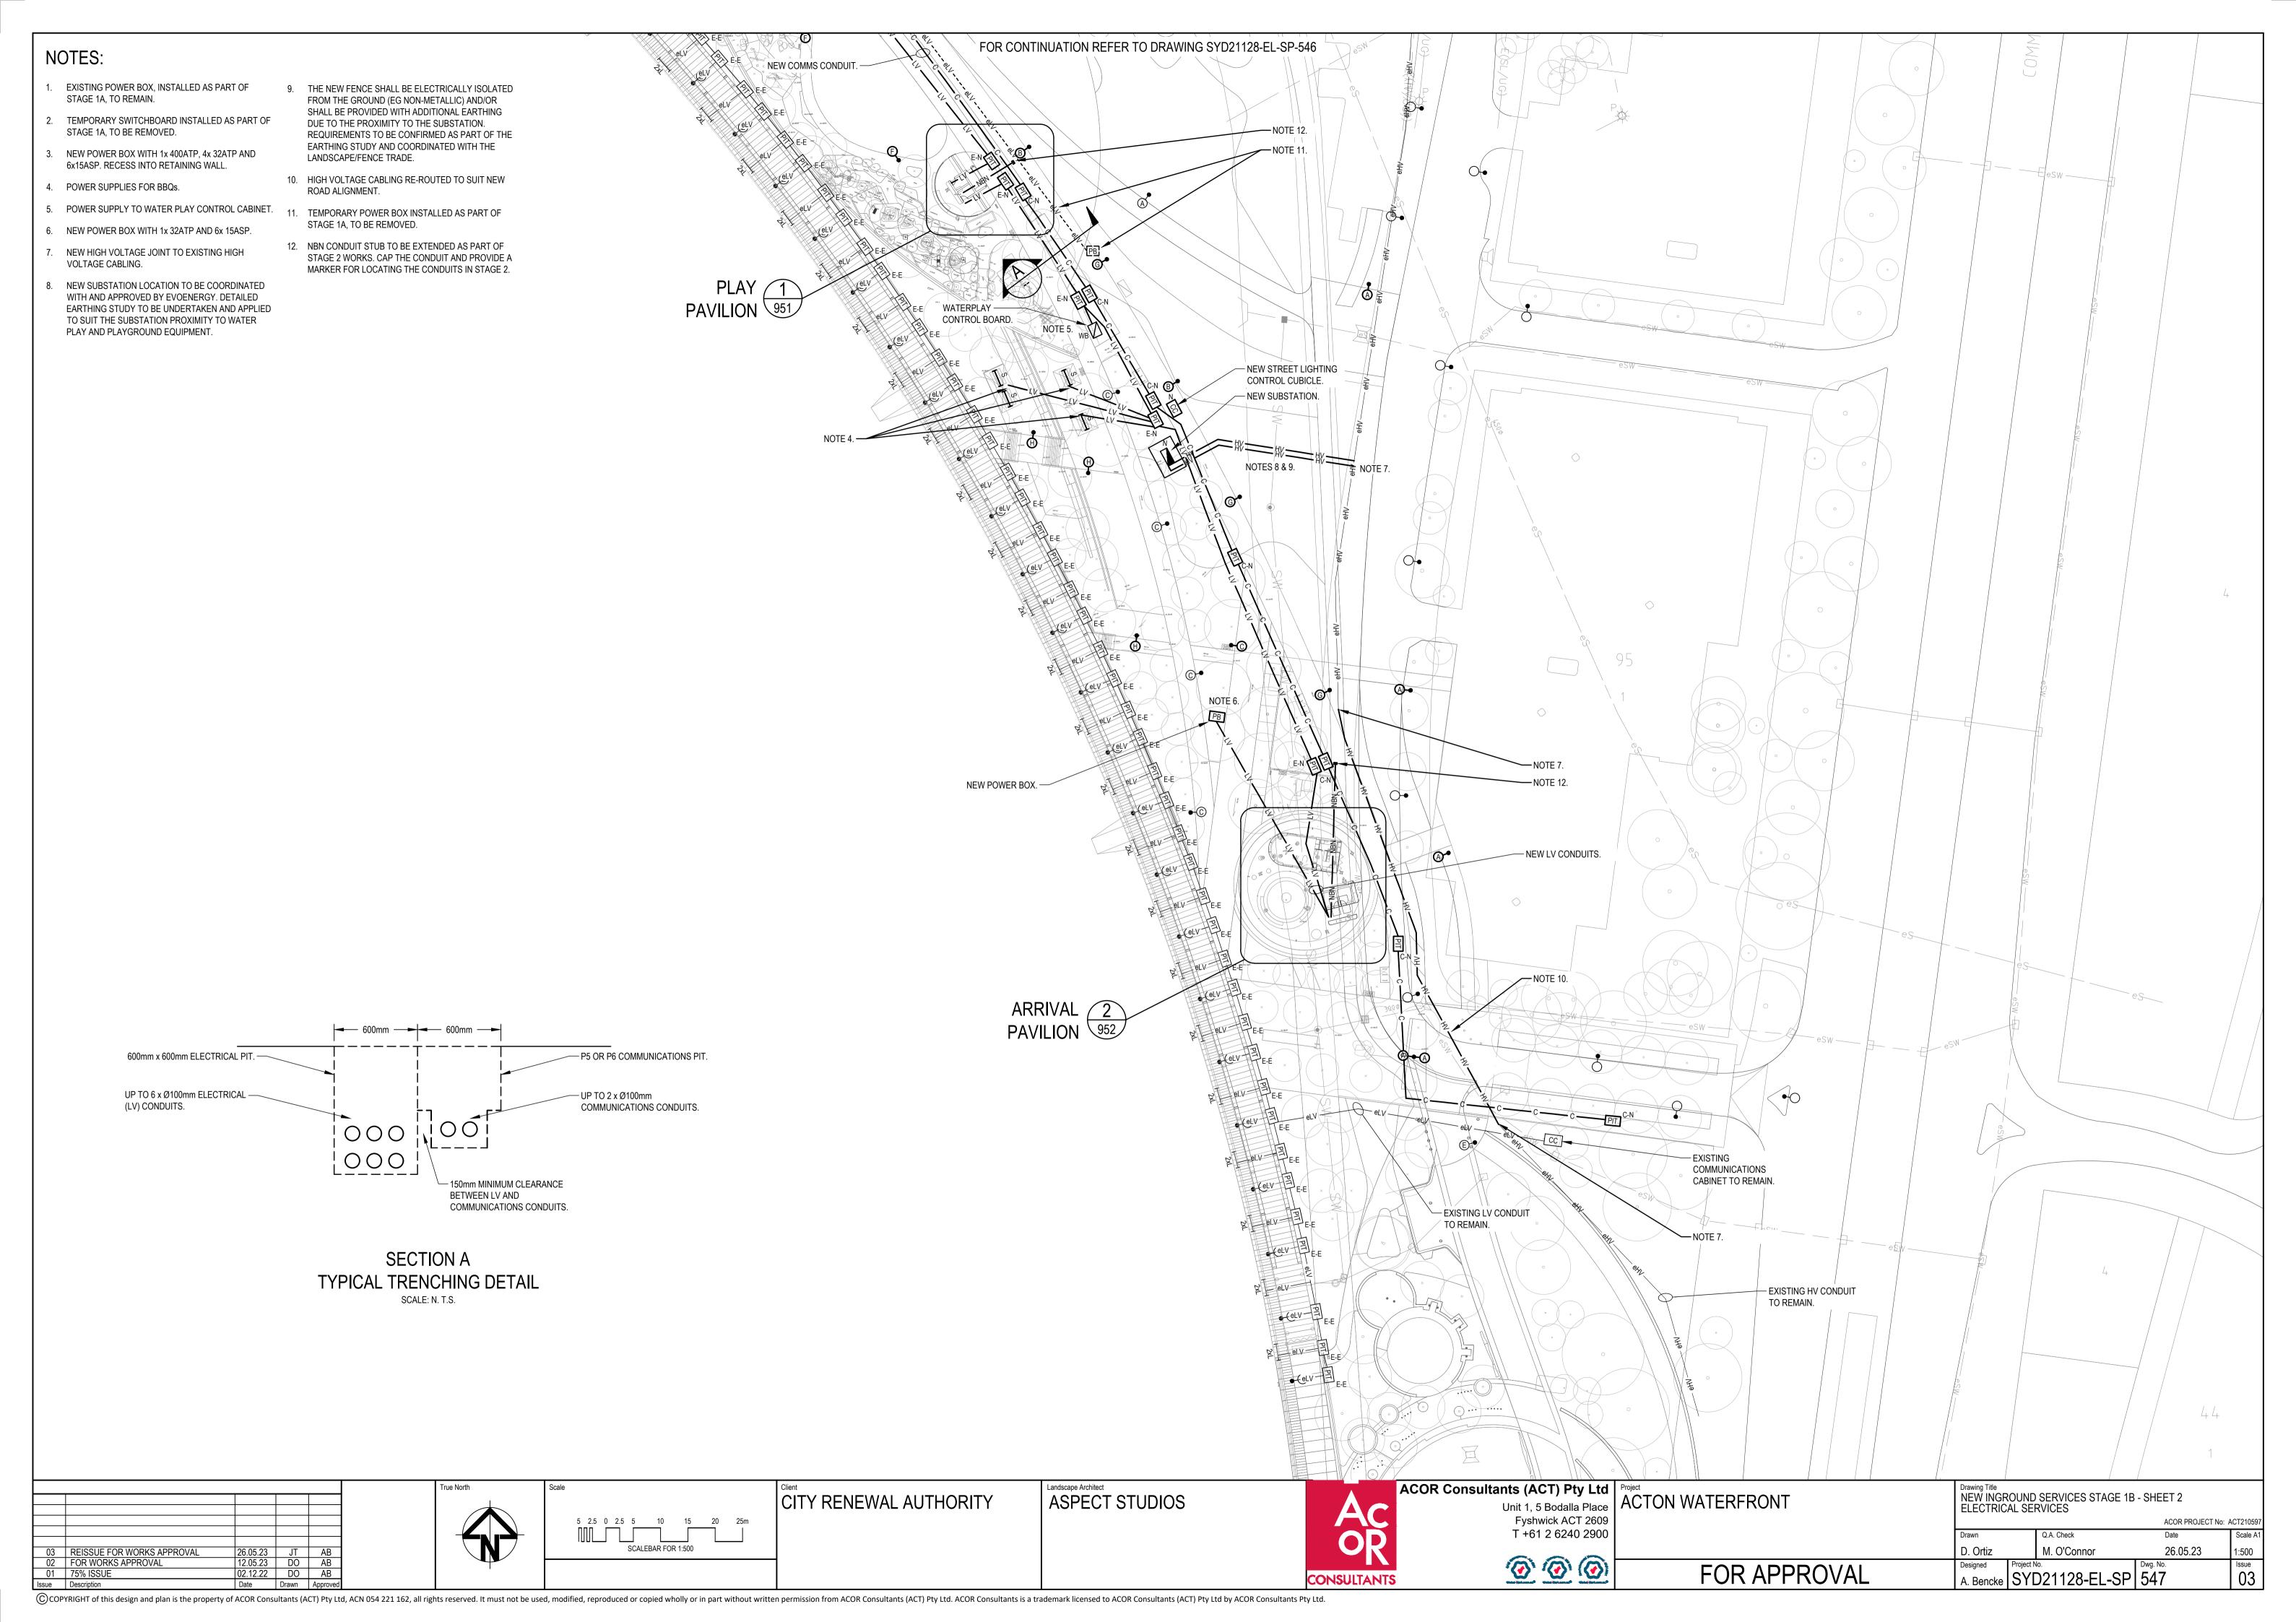
Project
ACTON WATERFRONT


Drawing Title
LEGEND
ELECTRICAL & MECHANICAL SERVICES ACOR PROJECT No: ACT210597 D. Ortiz 12.05.23 Designed Project No.
A. Bencke SYD21128-EL-SP 501 FOR APPROVAL

02 FOR WORKS APPROVAL 01 75% ISSUE







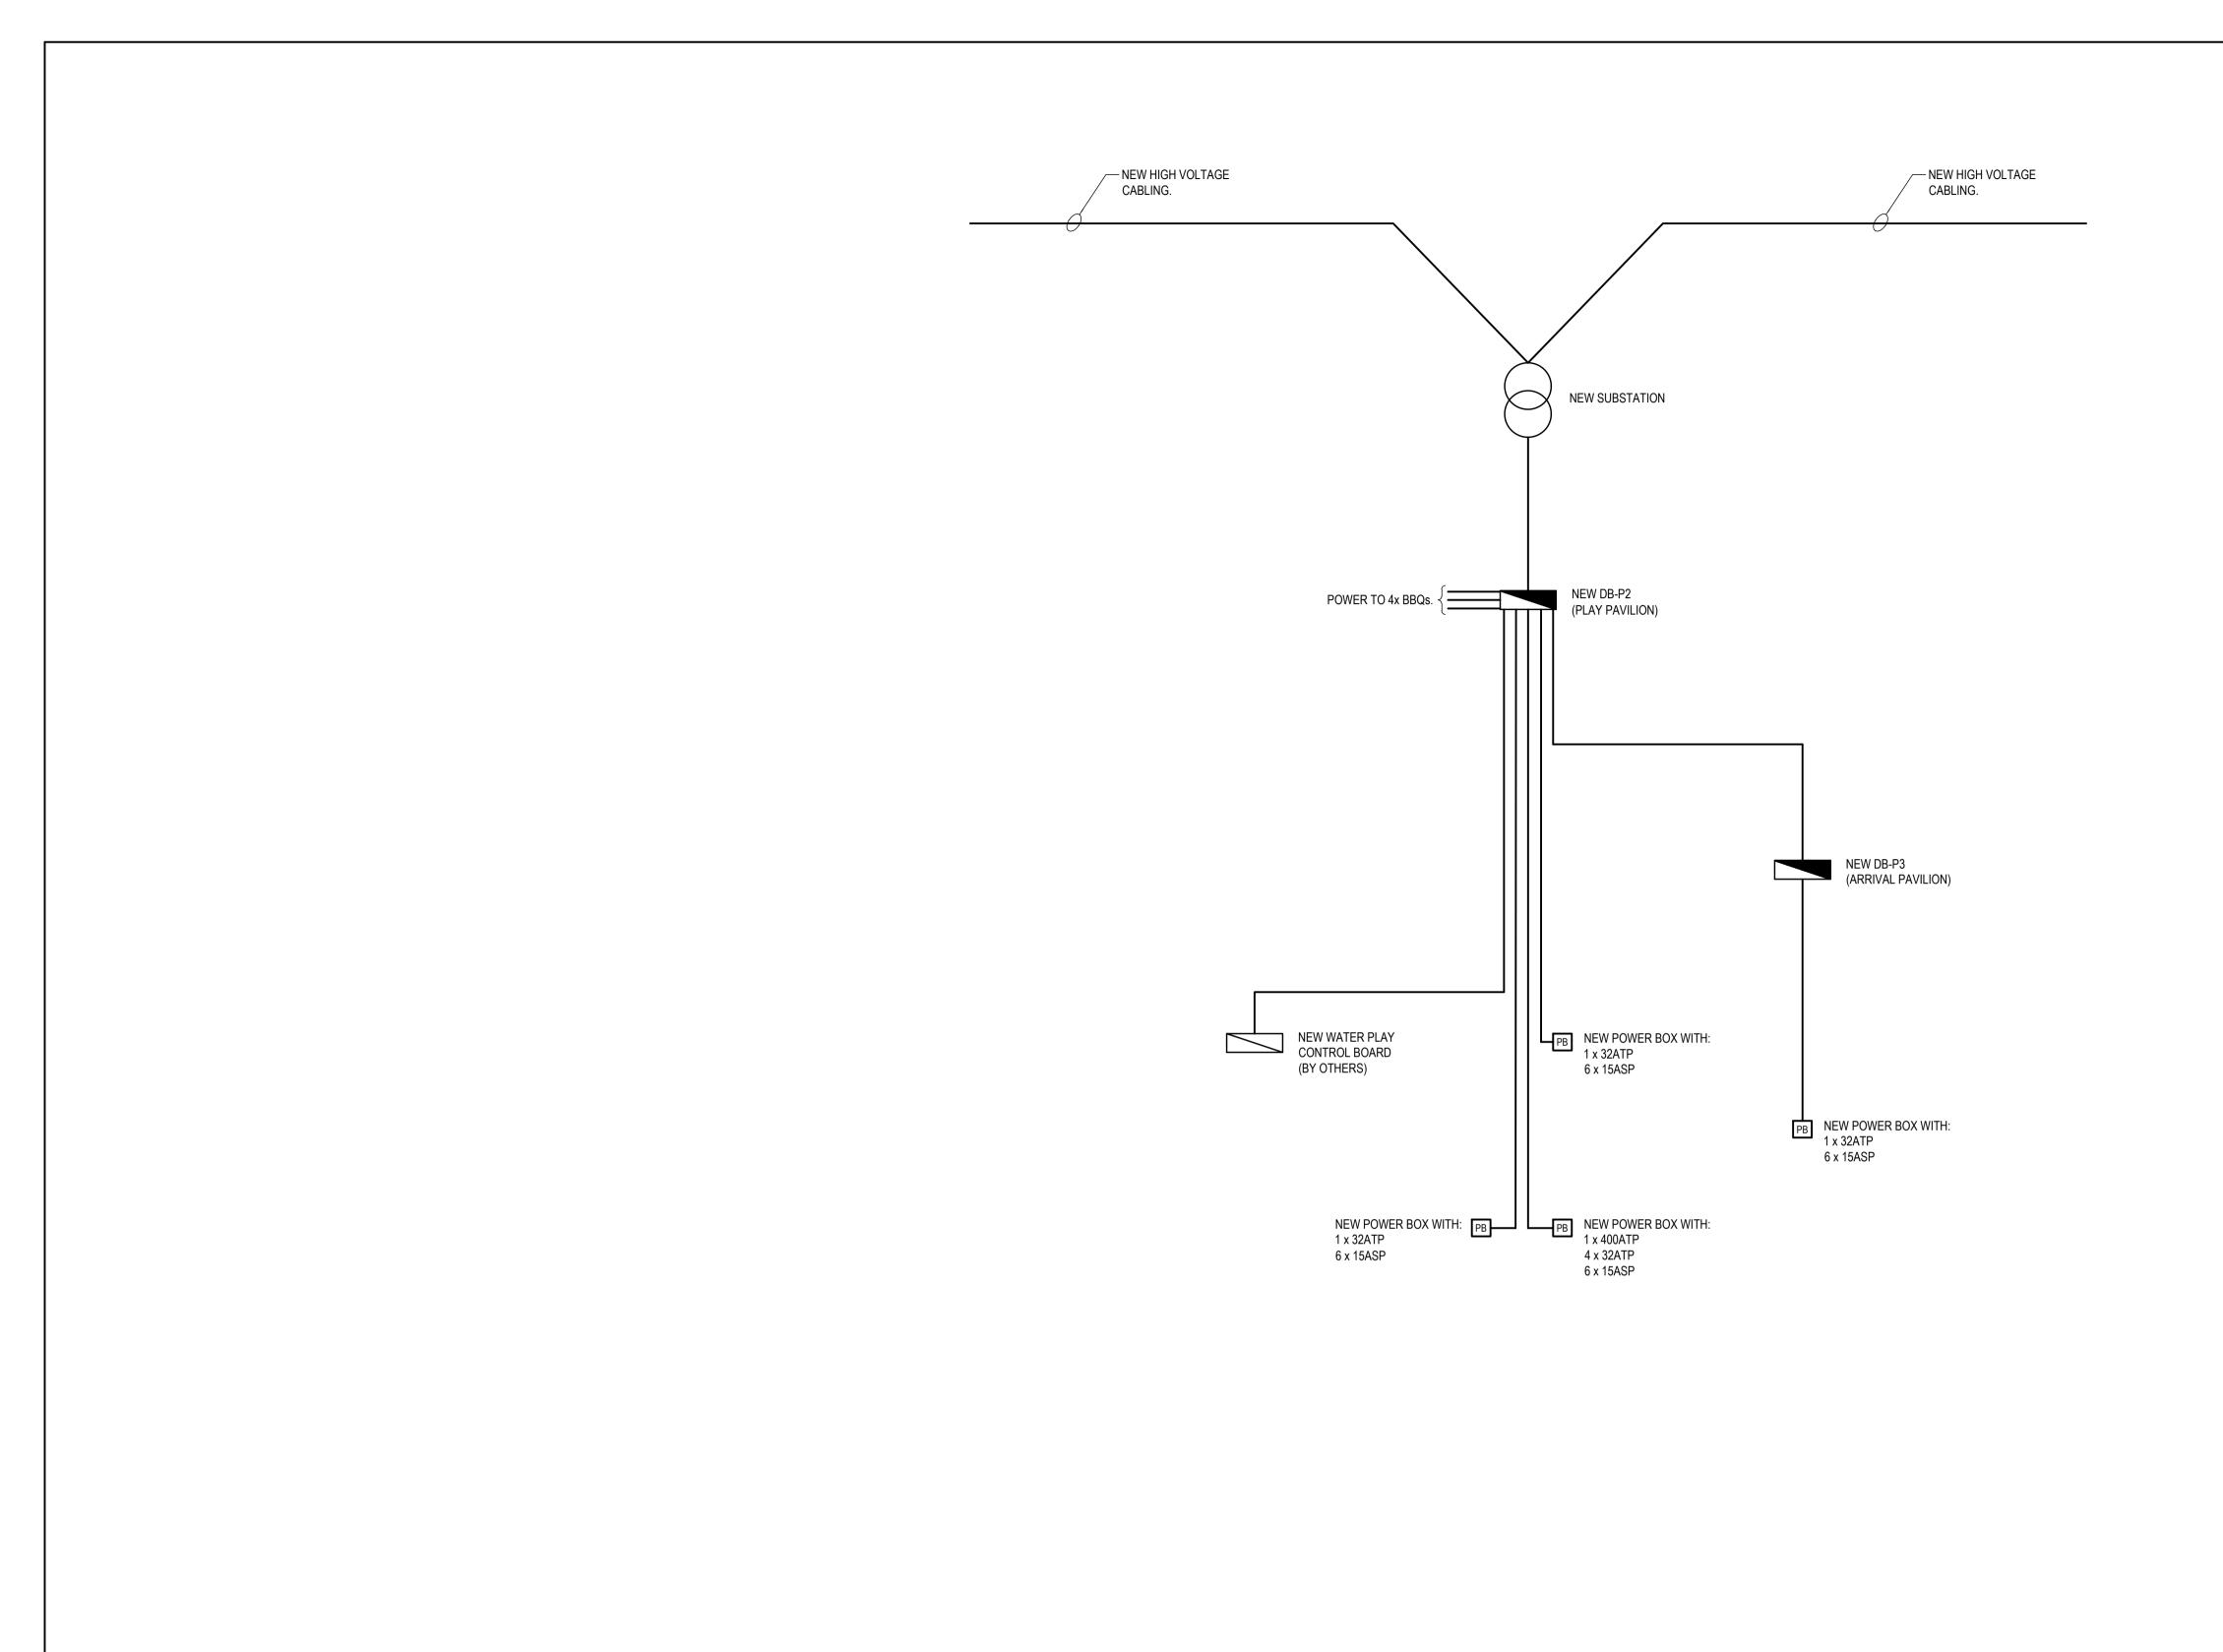

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