**PROJECT NAME:** 

# PIALLIGO VILLAGE AND ANIMAL REFERENCE HOSPITAL CIVIL ENGINEERING

**PROJECT LOCATION:** 

BLOCK 17 SECTION 2 PIALLIGO, ACT

**DEVELOPER'S NAME:** 

# TURCO & ASSOCIATES

## DRAWING INDEX

DRG No.	DRAWING TITLE
C001 C003 C101 C102 C103 C110 C111 C112 C201 C202 C203 C204 C300 C301 C302 C303 C310 C311 C312 C313 C314 C315 C320 C400 C401	TITLE SHEET, DRAWING LIST & LOCALITY PLAN GENERAL NOTES LANDSCAPE MANAGEMENT AND PROTECTION PLAN POLLUTION CONTROL PLAN SITE ESTABLISHMENT NOTES & DETAILS BULK EARTHWORKS PLAN BULK EARTHWORKS SECTIONS SHEET 1 BULK EARTHWORKS SECTIONS SHEET 2 EXTERNAL SERVICES PLAN EXTERNAL SERVICES DETAILS TRENCH BACKFILL DETAILS SHEET 1 TRENCH BACKFILL DETAILS SHEET 2 PAVEMENT PROFILES AND GENERAL NOTES PAVEMENT PLAN CIVIL DETAILS PLAN PAVEMENT DETAILS GRADING AND SETOUT PLAN GRADING AND SETOUT SECTIONS SHEET 1 GRADING AND SETOUT SECTIONS SHEET 2 GRADING AND SETOUT SECTIONS SHEET 3 GRADING AND SETOUT SECTIONS SHEET 5 SWALE SECTIONS STORMWATER MANAGEMENT NOTES AND DETAILS STORMWATER MANAGEMENT PLAN
C402 C501 C601 C701	STORMWATER LONGITUDINAL SECTIONS TURNING DEMONSTRATION PLAN TEMPORARY TRAFFIC MANAGEMENT PLAN TCD PLAN
<del>-</del> ·	






**JOB NUMBER:** 

# 161310


**SUBMISSION TYPE:** 


# DESIGN ACCEPTANCE

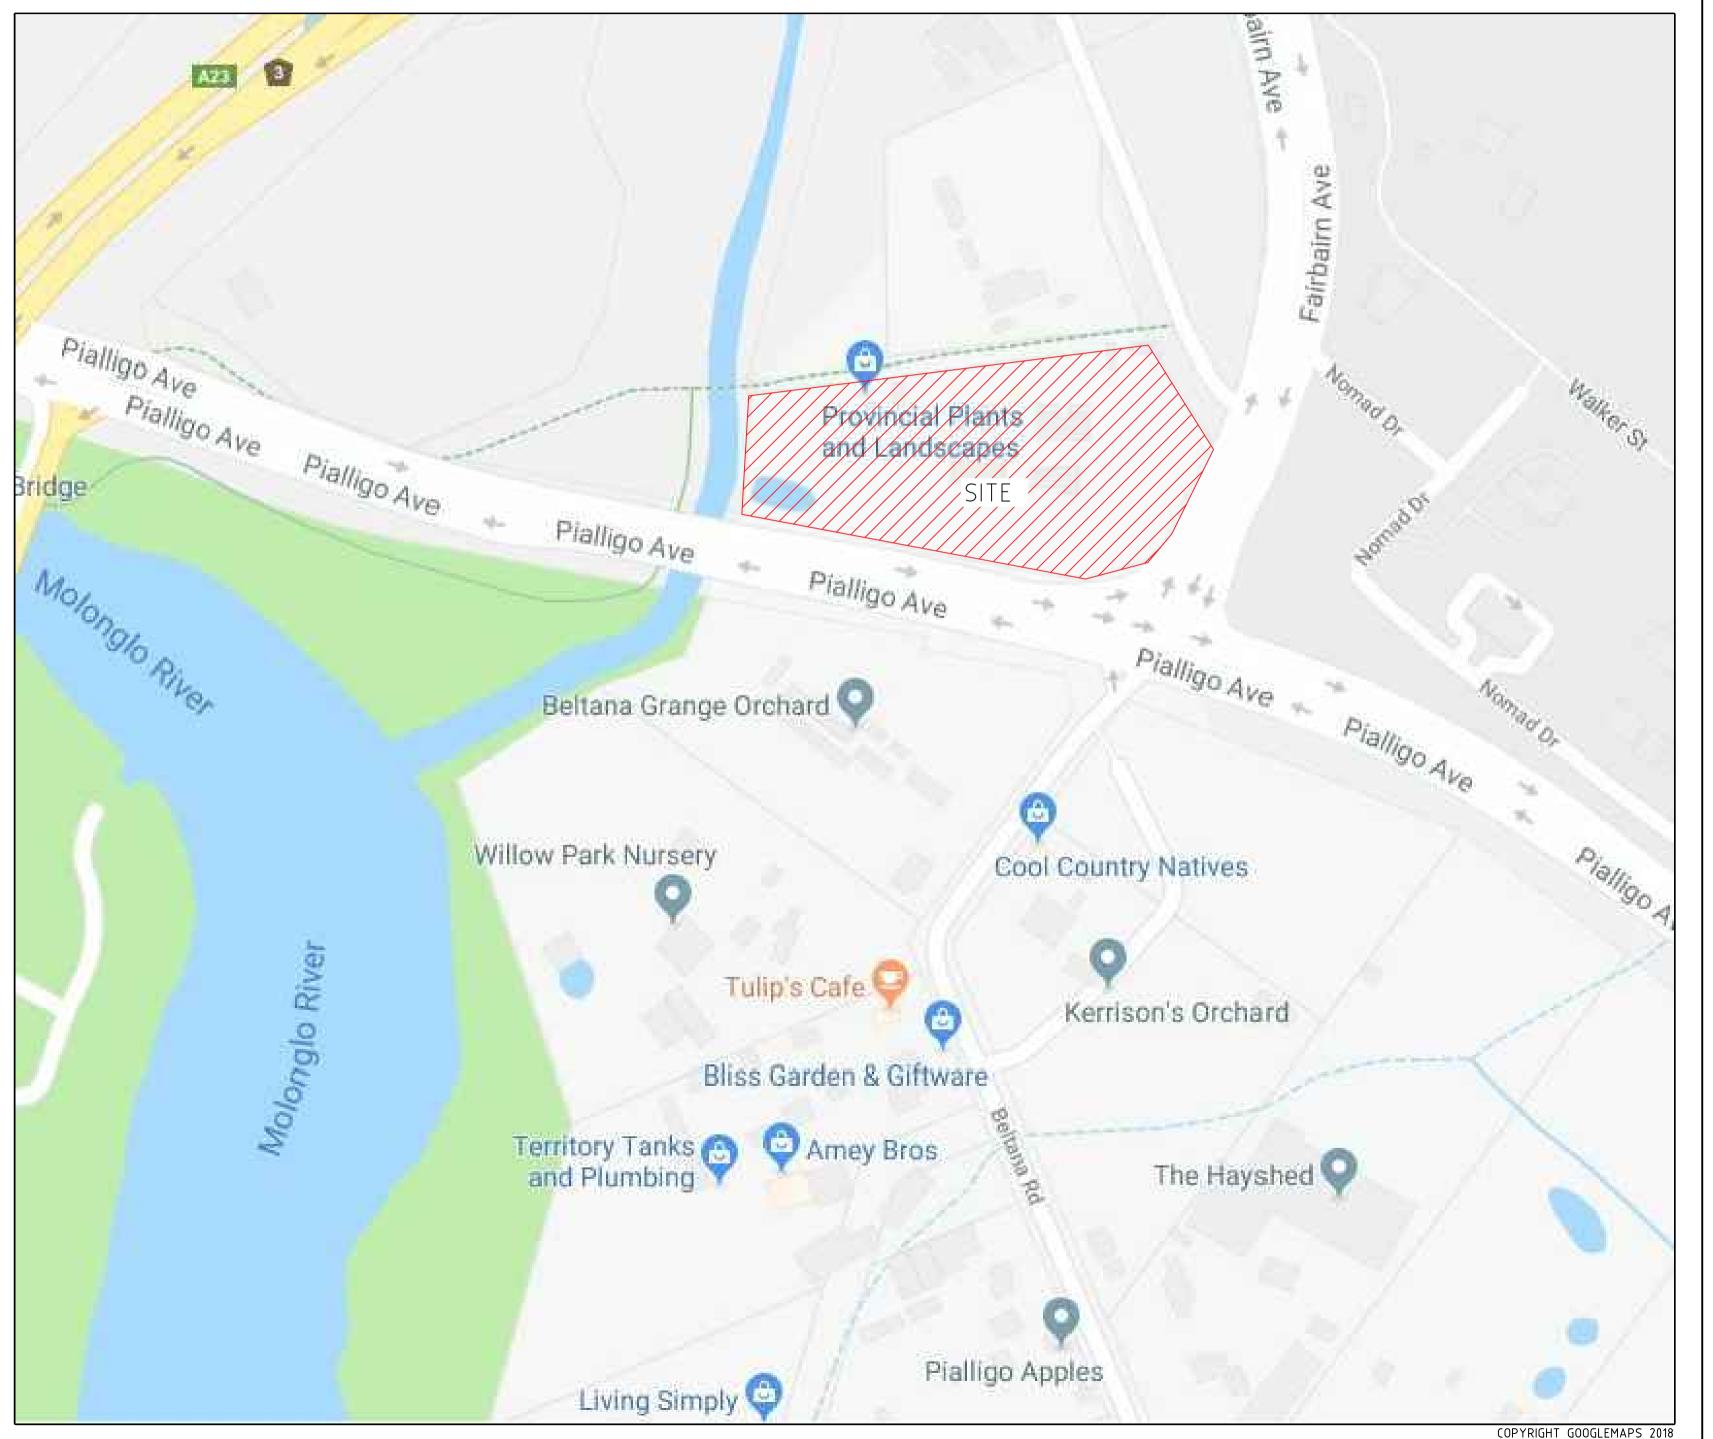

**LOCALITY PLAN** 

#### NOTATION UTILITIES NOTES 1. THE UTILITIES INDICATED ON THESE DRAWINGS WERE COMPILED FROM DIGITAL PLANS ALIGNMENT ISSUED BY UTILITY AUTHORITIES VIA THE DIAL BEFORE YOU DIG SERVICE. THE BARRIER KERB BK INFORMATION PROVIDED WAS PREPARED SOLELY FOR THE USE OF THE AUTHORITY AND CHAINAGE IS NOT NECESSARILY ACCURATE. CASTELLATED KERB COVER LEVEL 2. BEFORE COMMENCING WORK THE CONTRACTOR SHALL CONTACT THE RELEVANT UTILITY СТВ CONCRETE THRUST BLOCK AUTHORITIES AND VERIFY THE LOCATION OF ALL UNDERGROUND UTILITIES ON SITE AND CONCRETE THRUST PIER OBTAIN NECESSARY CLEARANCES FOR POTHOLING AND CONSTRUCTION. DISCREPANCIES DP BETWEEN THE CONSTRUCTION DRAWINGS AND THE PHYSICAL ONSITE CONDITIONS DOWN PIPE MUST BE REPORTED BACK TO THE DESIGN CONSULTANT MINIMUM 7 DAYS PRIOR TO FSL FINISHED SURFACE LEVEL COMMENCEMENT OF WORKS. FLUSH KERB HYDRANT 3. BEFORE COMMENCING EXCAVATION THE CONTRACTOR SHALL EXPOSE ALL CROSSINGS HER HIGH END RISER AND CONNECTIONS POINTS ON EXISTING UNDERGROUND UTILITIES. THE LEVELS OF HEAD WALL CONNECTION POINTS AND LEVELS OF EACH CROSSING SHALL BE SURVEYED AND ANY INVERT LEVEL VARIATIONS OF THE LEVELS GIVEN OR ANY DIFFICULTIES IN BEING ABLE TO ACHIEVE INTERSECTION POINT THE REQUIRED GRADES OF NEW PIPELINES SHALL BE REPORTED TO THE INTERMEDIATE RISER SUPERINTENDENT. K4A k4A KERB KR KERB RETURN 4. BEFORE COMMENCING WORK THE CONTRACTOR SHALL ARRANGE THE RELOCATION OR KERB AND GUTTER KG ADJUSTMENT OF A UTILITY SERVICE TO THE APPROVAL OF THE RELEVANT UTILITY KERB ONLY AUTHORITY. MANHOLE 5. BEFORE COMMENCING WORK THE CONTRACTOR SHALL LOCATE AND MARK ALL UTILITIES MOUNTABLE KERB WITHIN THE EXTENT OF WORKS. MKG MOUNTABLE KERB AND GUTTER MOWING STRIP 6. IF AN UNDERGROUND SERVICE IS DAMAGED DURING CONSTRUCTION THE CONTRACTOR 001 OPEN CONCRETE INVERT SHALL NOTIFY THE SUPERINTENDENT AND THE RELEVANT UTILITY AUTHORITY PRAM CROSSING IMMEDIATELY. ANY DAMAGE TO EXISTING UTILITIES SHALL BE REPAIRED AT NO EXTRA PTB PIER THRUST BLOCK COST TO THE PRINCIPLE. $\mathsf{PR}$ PRAM RAMP REDUCED LEVEL ROCI REINFORCED OPEN CONCRETE INVERT RVC REINFORCED VEHICLE CROSSING ICON WATER NOTES STOP COCK SUBSOIL 1. ALL WORK ON ICON WATER WATER SUPPLY AND SEWER MAINS TO BE CARRIED OUT IN STOP VALVE S٧ ACCORDANCE WITH CURRENT STANDARDS: TANGENT POINT TRENCH STOP WSA-02 'GRAVITY SEWERAGE CODE OF AUSTRALIA' THRUST WALL - STD-SPE-G-011 'ICON WATER SUPPLEMENT TO WSA-02' VEHICULAR CROSSING WSA-03 'WATER SUPPLY CODE OF AUSTRALIA' - STD-SPE-G-012 'ICON WATER SUPPLEMENT TO WSA-03' - STD-SPE-M-006 'REQUIREMENTS FOR PROPERTY SERVICE CONNECTIONS' GENERAL NOTES ALL WORK ON STORMWATER MAINS TO BE CARRIED OUT IN ACCORDANCE WITH DESIGN STANDARDS FOR URBAN INFRASTRUCTURE AND STANDARD SPECIFICATION FOR URBAN 1. THE CONTRACTOR MUST COMPLY WITH CURRENT WORK AND HEALTH AND SAFETY INFRASTRUCTURE WORKS. LEGISLATION, REGULATIONS AND THE CODES OF PRACTICE. CONNECTIONS AND OR DISCONNECTIONS OF SEWER AND WATER AT THE MAIN TO BE MADE BY 2. THE CONTRACTOR MUST SECURE ALL PERMITS. ARRANGE ALL CLEARANCES AND PAY ALL ICON WATER AT CONTRACTOR'S EXPENSE. THE CONTRACTOR IS TO EXPOSE THE MAIN AT THE FEES REQUIRED TO COMPLETE THE PROJECT BEFORE COMMENCING WORK OR PRIOR TO THEM LOCATION OF THE CONNECTION/DISCONNECTION IN PREPARATION FOR THE WORK BY ICON CAUSING DELAY TO THE PROJECT. WATER. ALL EXCAVATION IN THE VICINITY OF MAINS IS TO BE CARRIED OUT BY HAND. 3. THE CONTRACTOR IS RESPONSIBLE FOR ALL CONSTRUCTION WORKS BEING CARRIED OUT IN 3. THE CONTRACTOR MUST VISIT THE SITE OF WORKS BEFORE TENDERING AND MAKE ACCORDANCE WITH CONTRACT DOCUMENTS. ALLOWANCES IN HIS TENDER FOR ALL TOPOGRAPHIC CONSTRAINTS AFFECTING THE EXECUTION OF THE WORKS AND THE RESTORATION OF THE SITE. 4. THE CONTRACTOR SHALL VERIFY ALL DIMENSIONS AND EXISTING LEVELS WITHIN THE SITE PRIOR TO COMMENCEMENT OF WORKS. ANY DISCREPANCIES SHALL BE REFERRED TO THE 4. ALTHOUGH THE POSITIONS OF EXISTING UNDERGROUND SERVICES HAVE BEEN PLOTTED FROM DESIGN CONSULTANT A MINIMUM 7 DAYS PRIOR TO COMMENCEMENT OF ASSOCIATED WORKS. AVAILABLE RECORDS, THE CONTRACTOR SHALL CONFIRM THE DEPTH AND LOCATION OF ALL SERVICES ON SITE BEFORE COMMENCING EXCAVATIONS. CONTRACTOR TO ADVISE DESIGN 5. THE CONTRACTOR SHALL ENSURE DISTURBED SURFACES OUTSIDE THE GENERAL LIMIT OF ENGINEER IF NOT IN ACCORDANCE WITH THE PLAN. WORK IS REINSTATED AT THE CONTRACTORS EXPENSE, TO THE SUPERINTENDENTS SATISFACTION, THESE SURFACES INCLUDE BUT ARE NOT LIMITED TO ROAD PAVEMENTS. 5. ALL LEVELS ARE TO AUSTRALIAN HEIGHT DATUM (AHD). ALL COORDINATES ARE BASED ON KERBS, VERGE PAVING OR GRASSING, PEDESTRIAN FOOTPATHS AND DRIVEWAYS. THE ACT STANDARD GRID SYSTEM (STROMLO PROJECTION). THE CONTRACTOR IS RESPONSIBLE FOR MAKING SMOOTH CONNECTION TO EXISTING. 6. THE CONTRACTOR MUST SECURE ALL PERMITS, ARRANGE ALL CLEARANCES AND PAY ALL FEES REQUIRED TO COMPLETE THE PROJECT BEFORE COMMENCING WORK. 7. THE CONTRACTOR IS RESPONSIBLE FOR MAINTAINING ALL TEMPORARY EARTHWORKS IN A STABLE CONDITION DURING CONSTRUCTION. TEMPORARY SHORING AND BATTERING MUST BE 7. WORK AS EXECUTED DRAWINGS, TIE BOOK AND DEPOSITED PLAN MUST BE SUBMITTED BEFORE IN ACCORDANCE WITH AS3798 8. THE CONTRACTOR SHALL MAKE PROVISIONS FOR BOTH VEHICULAR AND PEDESTRIAN 8. ANY NON-METALLIC WATER SERVICE IS TO BE INSTALLED WITH TRACER WIRE AND TESTED. TRAFFIC AND SITE VISITORS. THE CONTRACTOR MUST ENSURE SAFE ACCESS FOR NON CONSTRUCTION PEOPLE. 9. EXCESS EXCAVATED MATERIAL SHALL BE REMOVED FROM SITE AND DISPOSED OF AT AN APPROVED SPOIL AREA. 9. THE CONTRACTOR IS RESPONSIBLE FOR THE PREPARATION OF ALL NECESSARY TEMPORARY TRAFFIC MANAGEMENT PLANS APPROVED IN ACCORDANCE WITH AS1742.3 AND RELEVANT 10. THE CONTRACTOR SHALL REINSTATE ALL DISTURBED SURFACES TO MATCH EXISTING. AUTHORITY REQUIREMENTS. 11. THE CONTRACTOR IS RESPONSIBLE FOR THE PREPARATION OF ALL NECESSARY TEMPORARY 10. THE CONTRACTOR IS RESPONSIBLE FOR THE PREPARATION OF ALL NECESSARY POLLUTION TRAFFIC MANAGEMENT PLANS AND THEIR APPROVAL. CONTROL PLANS AND THEIR APPROVAL. 12. CONTRACTOR TO CONFIRM DEPTH OF SEWER AND STORMWATER TIE POINTS PRIOR TO 11. THE CONTRACTOR SHALL ENSURE ALL MATERIALS AND WORKMANSHIP IS IN ACCORDANCE COMMENCEMENT OF CONSTRUCTION. ADVISE DESIGN ENGINEER IF NOT IN ACCORDANCE WITH WITH RELEVANT CURRENT CODES, STANDARDS, CONTRACT REQUIREMENTS AND AUTHORITY 13. ANY DEVIATION OF PIPE MATERIAL TO BE PROPOSED TO ENGINEER PRIOR TO INSTALLATION. 12. THE CONTRACTOR SHALL LIAISE WITH ALL ADJACENT CONTRACTS TO ENSURE ALL ALIGNMENTS AND LEVELS OF NEW OR RELOCATED UTILITIES ARE COMPATIBLE. 13. THE INFORMATION PROVIDED IN THESE DRAWINGS PREPARED BY SELLICK CONSULTANTS IS SEWER EXPLANATIONS SOLELY FOR THE USE OF THE RECIPIENT. SELLICK CONSULTANTS HAS NO DUTY OF CARE OR ACCEPTS ANY RESPONSIBILITY FOR A THIRD PARTY WHO MAY RELY UPON THESE DOCUMENTS FOR ANY PURPOSE. PIPE INFORMATION BOX ulL557.39 14. THESE DRAWINGS SHALL BE READ IN CONJUNCTION WITH OTHER ENGINEERING/ UPSTREAM INVERT LEVEL ARCHITECTURAL DRAWINGS AND SPECIFICATIONS OR OTHER WRITTEN INSTRUCTION THAT Ø 150 PIPE INTERNAL DIAMETER MAY BE ISSUED DURING THE TIME OF THE CONTRACT. uPVC SN8 PIPE MATERIAL RCP, VC OR PVC 2.0% PIPE GRADE 15. BLOCK BOUNDARIES SHOWN ON THESE DRAWINGS ARE IN ACCORDANCE WITH SUPPLIED PIPE LENGTH 3.6m DIGITAL DATA OR SURVEYED. DOWNSTREAM INVERT LEVEL dIL557.315 16. DO NOT SCALE THESE DRAWINGS. SEWER STRUCTURE ID 17. ALL DIMENSIONS ARE IN MILLIMETERS OR METERS. 18. ALL LEVELS ARE TO AUSTRALIAN HEIGHT DATUM (AHD). SEWER LINE S2, SEWER STRUCTURE '1' 19. ORIGIN OF SURVEYED AND DESIGN COORDINATES - MOUNT STROMLO 200000E, 600000N DRAWING TITLE DESIGNED BY DR JACOB MICHELSEN TURCO AND ASSOCIATES PIALLIGO VILLAGE AND ANIMAL GENERAL NOTES AM sellick consultants NOT TO SCALE CHECKED BY REFERENCE HOSPITAL CO STRUCTURAL CIVIL HYDRAULIC AUTHORISED BY PROJECT LOCATION DO NOT SCALE OFF DRAWINGS DRAWING NO. REV. JOB NO. canberra sydney brisbane BLOCK 17 SECTION 2 VERIFY ALL DIMENSIONS ON SITE BEFORE COMMENCING WORK. C003 COPYRIGHT: The concepts and information contained in this document are copyright of Sellick DATE 02 6201 0200 www.sellickconsultants.com.au FOR DESIGN ACCEPTANCE 01.02.19 PIALLIGO, ACT Consultants. Use or copying of this document in whole or in part without written permission constitutes 01/02/2019 ISSUE DESCRIPTION DATE DRAWN an infringement of copyright.

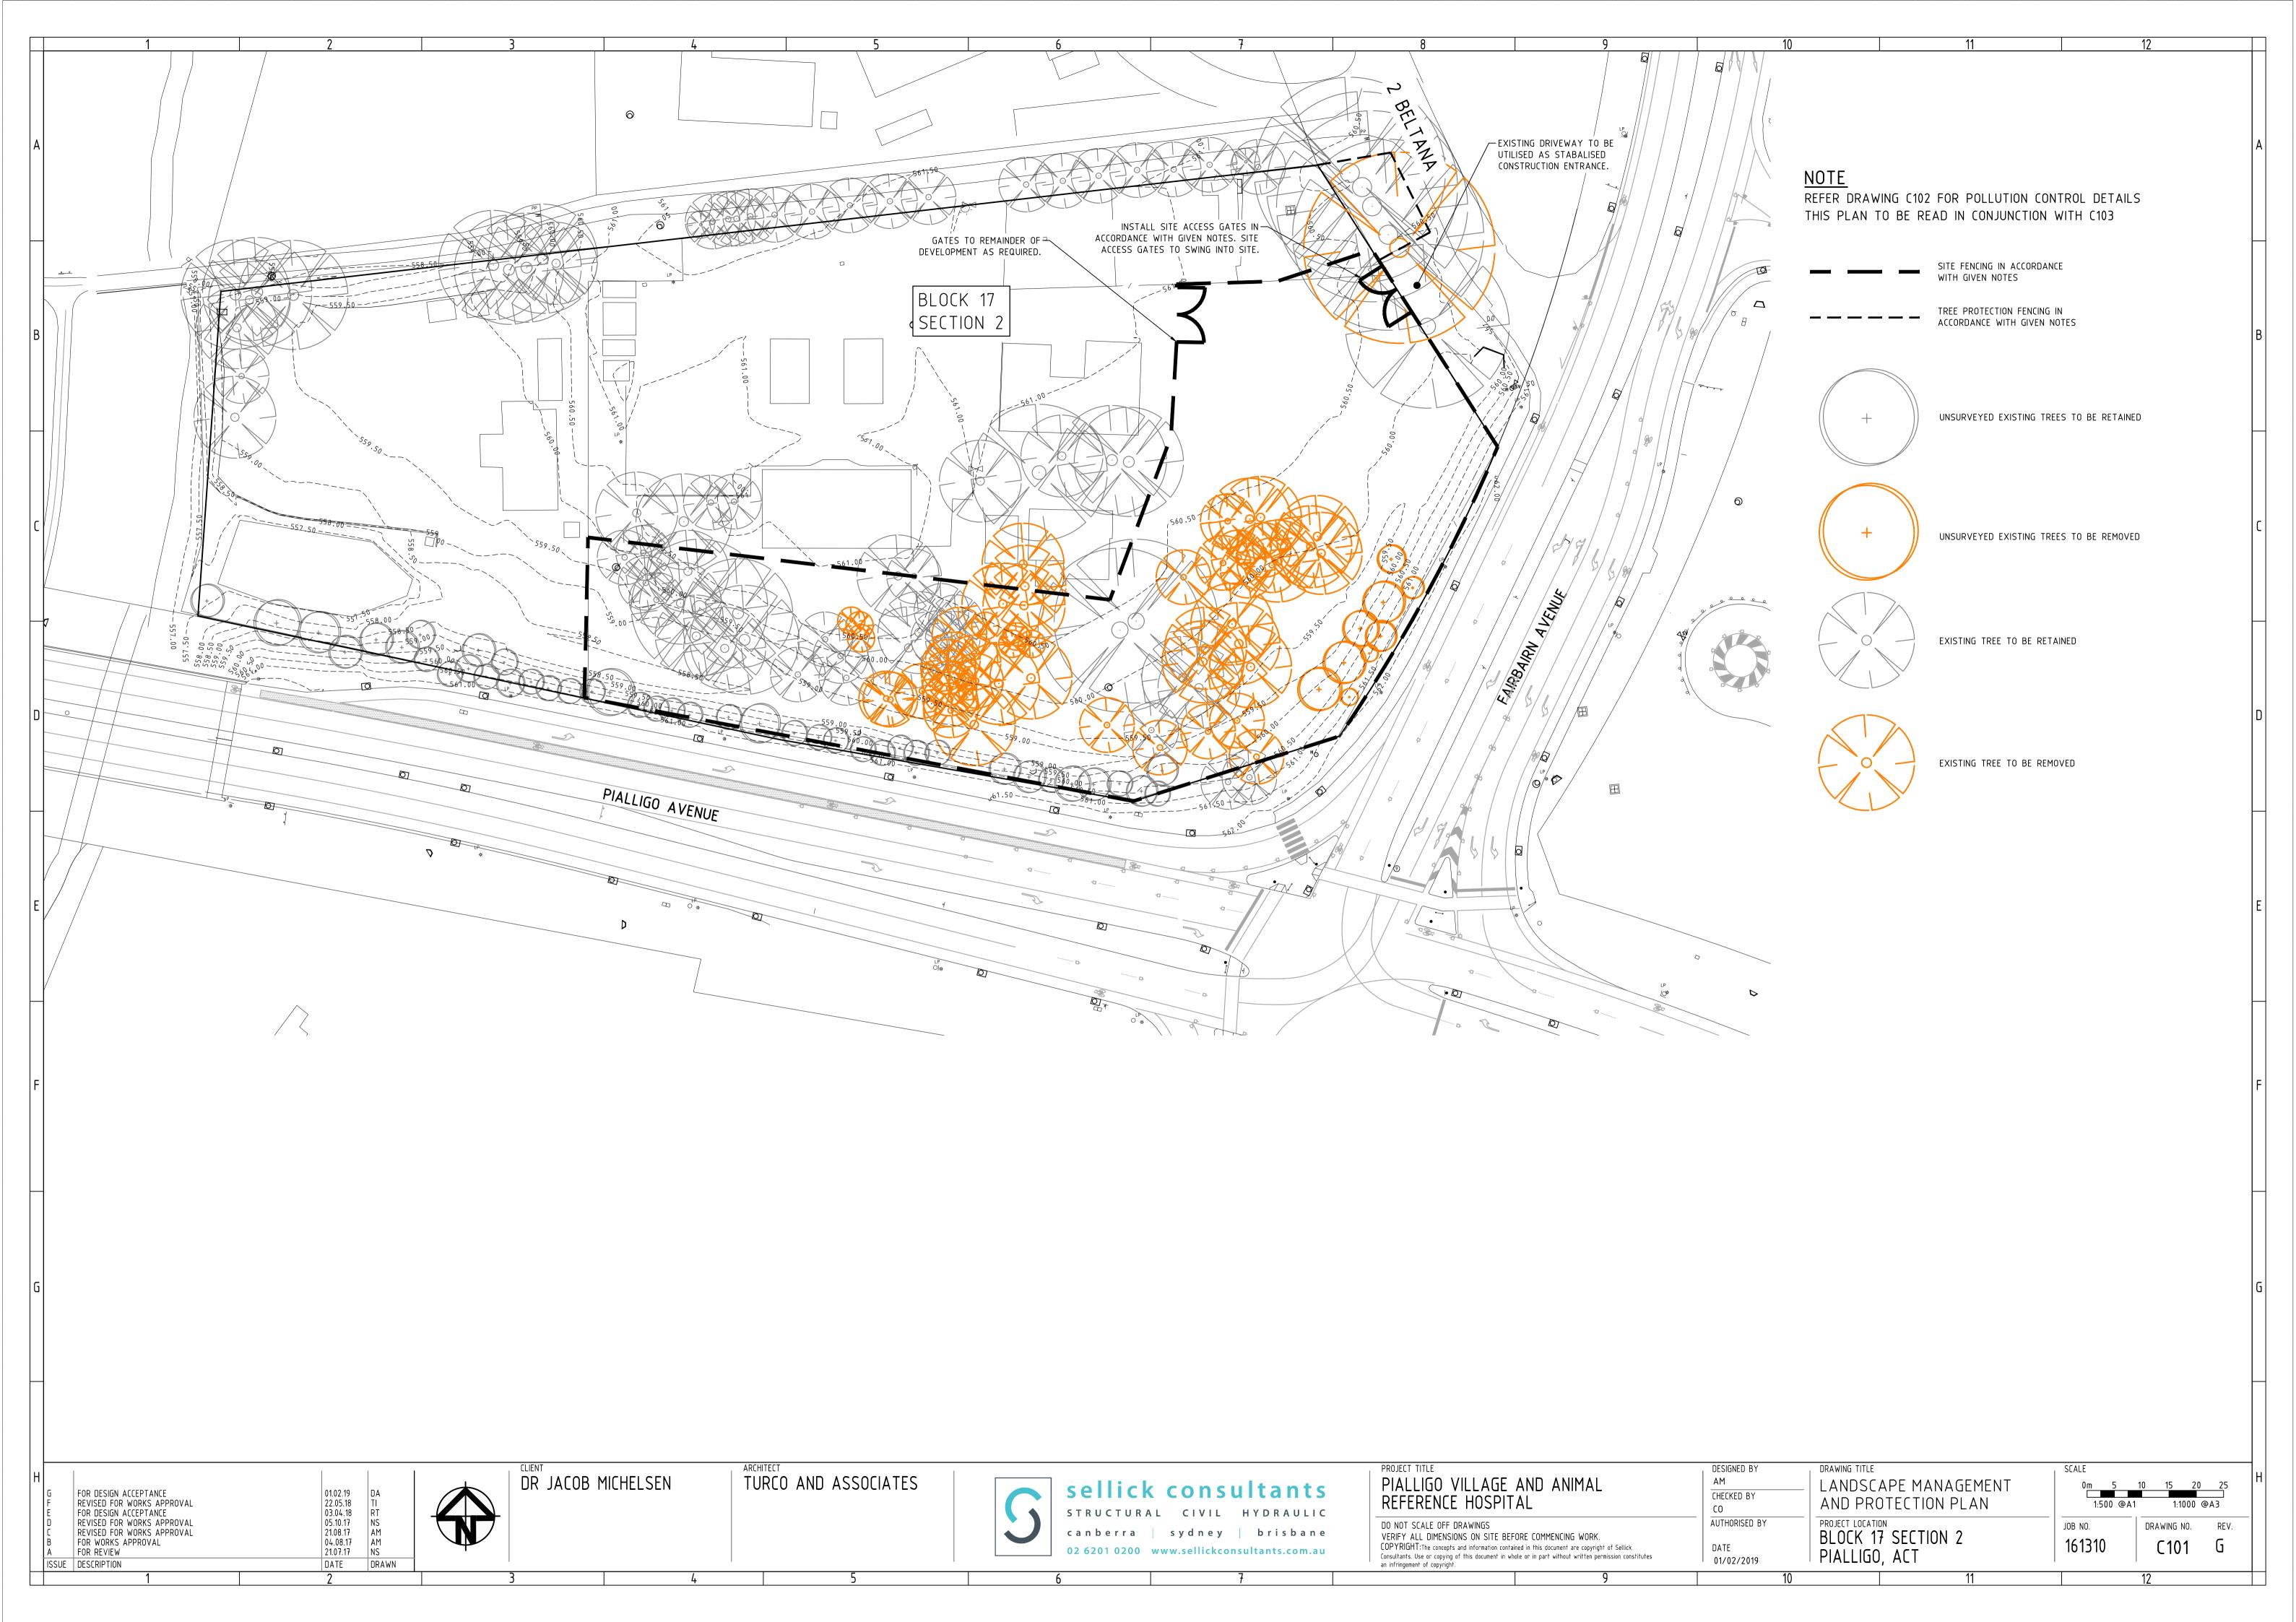


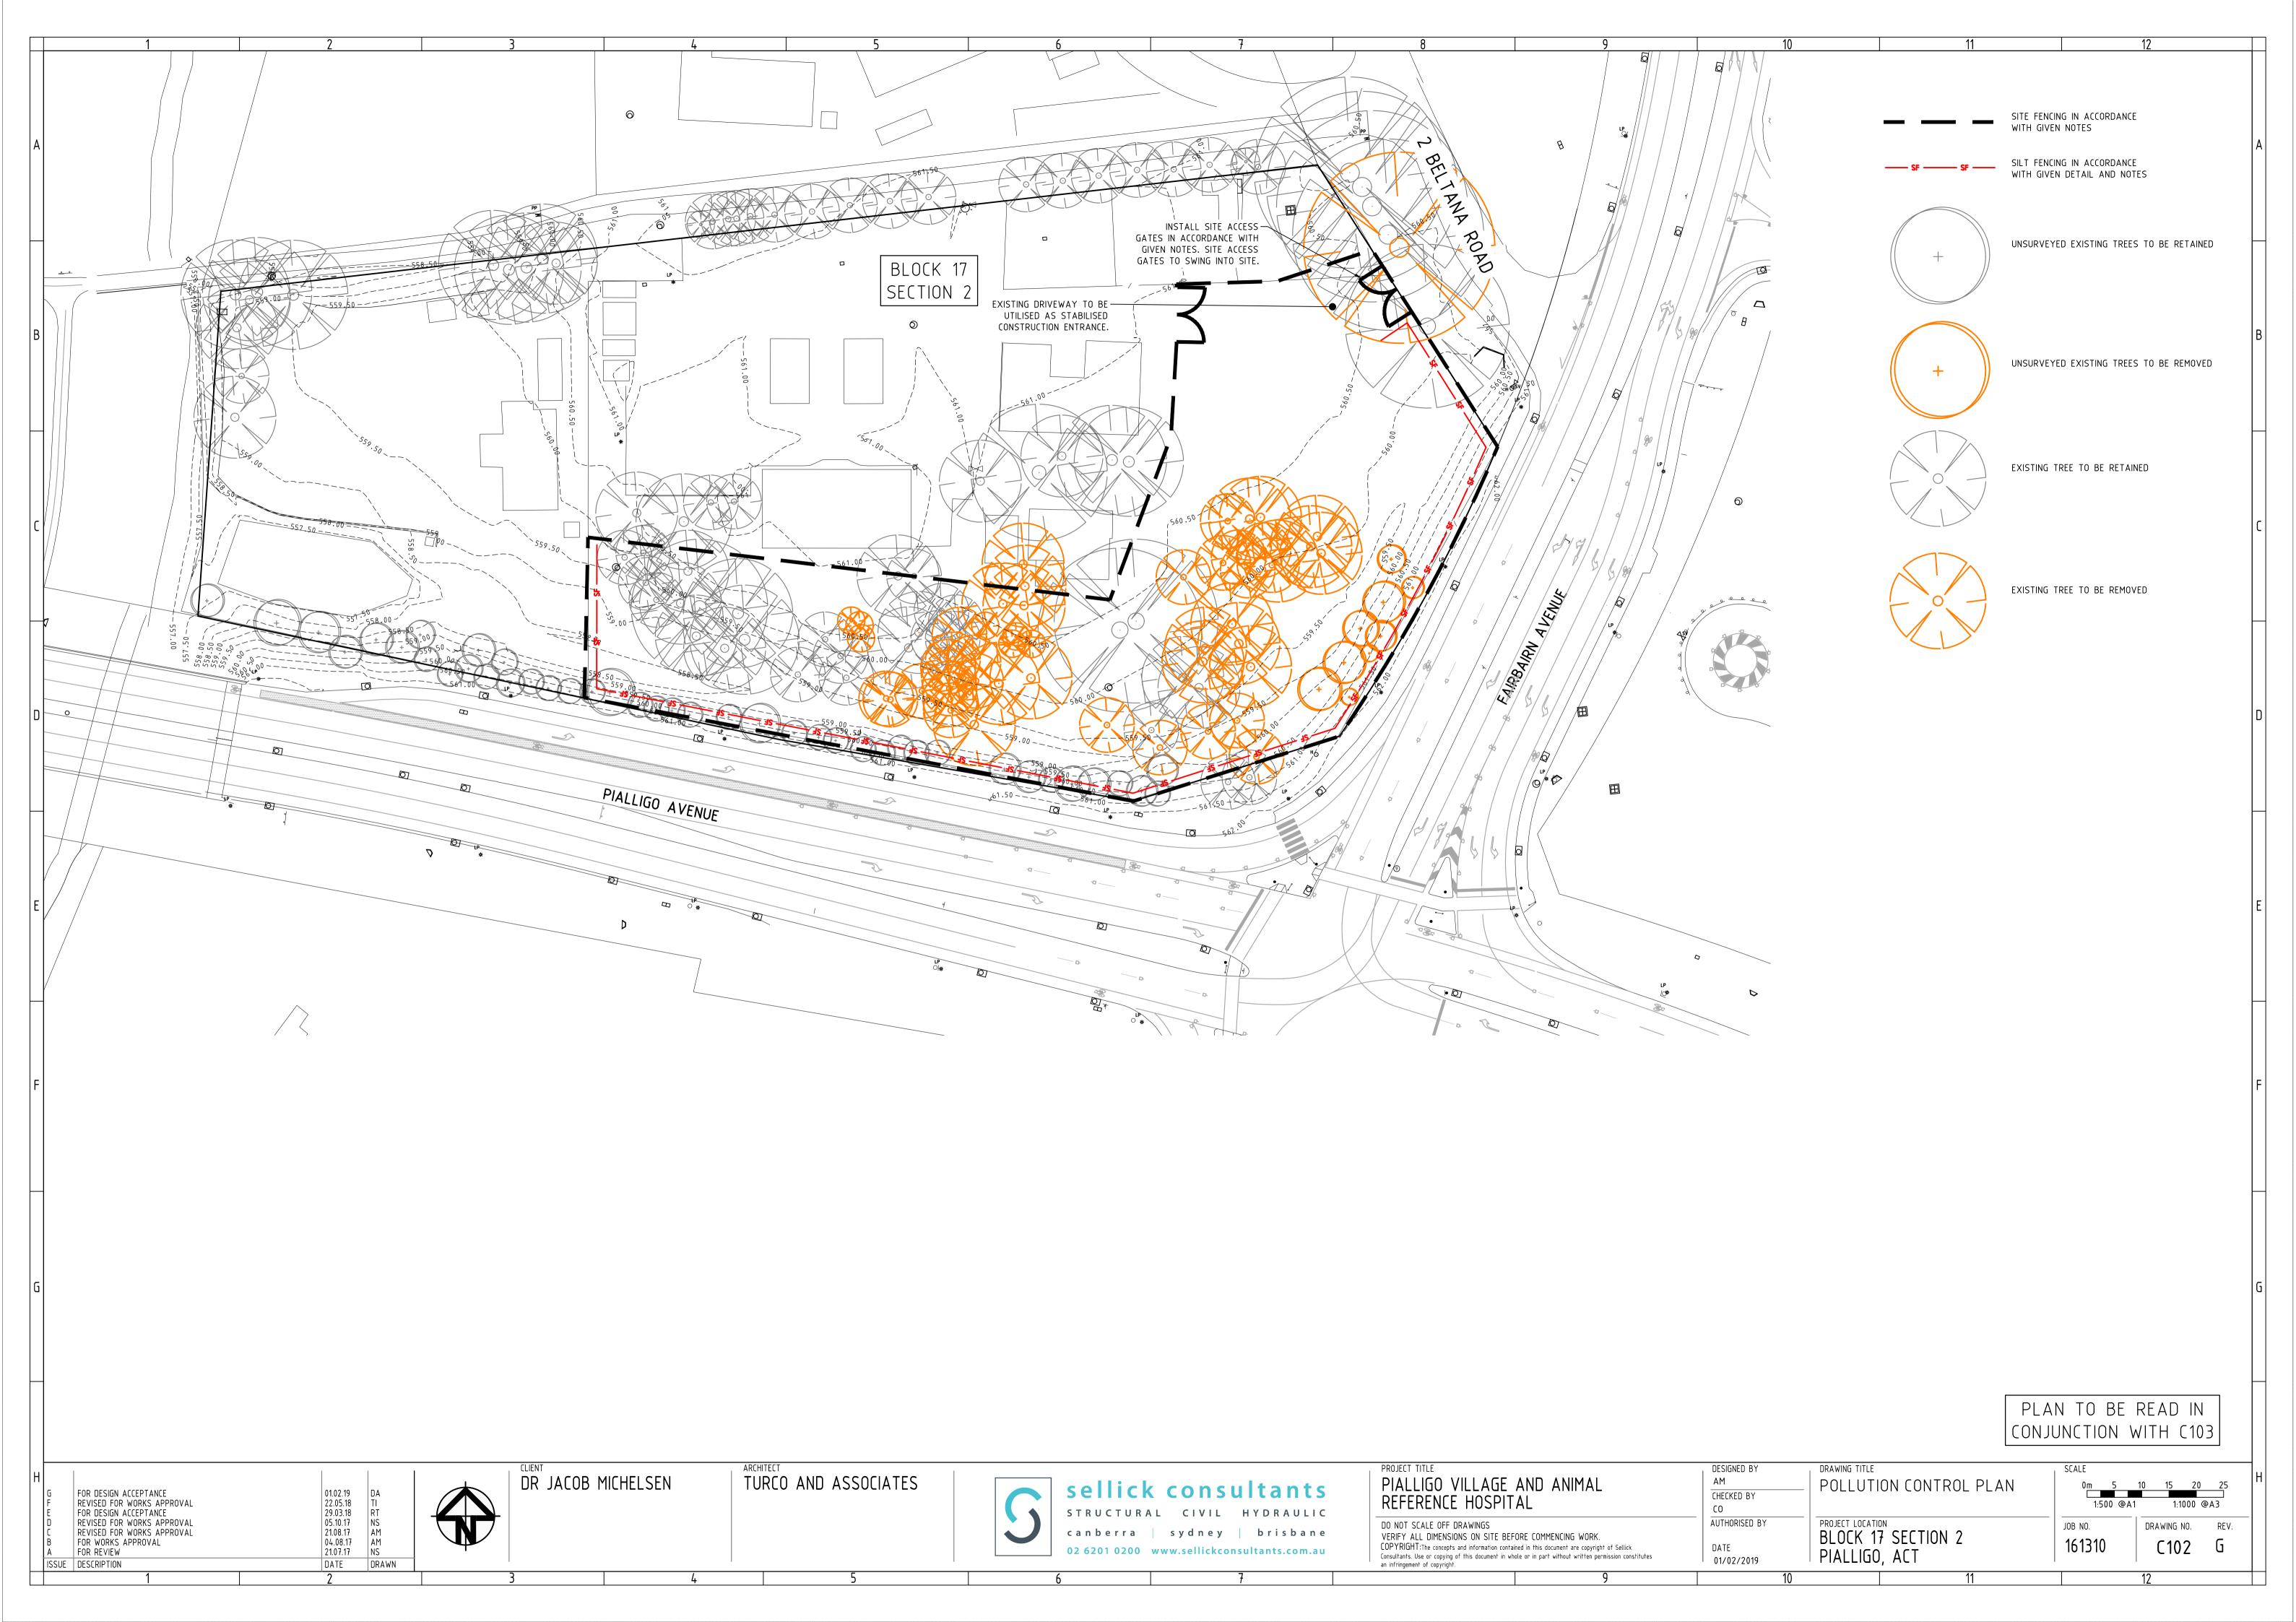

NOT TO SCALE

GEOTEXTILE FABRIC SEDIMENT CONTROL BARRIER SECTION

NOT TO SCALE

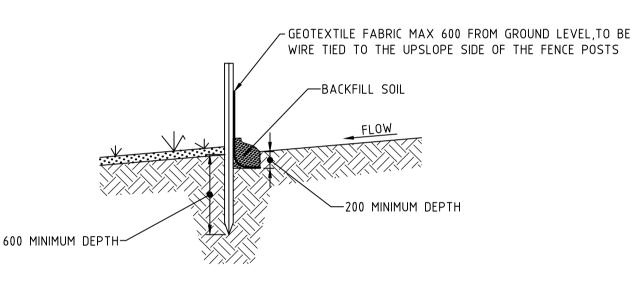

#### CONTACT DETAILS

PROJECT MANAGER: TBC

#### SITE MANAGER: TBC

WASTE NOTES WASTE ENCLOSURE(S) ARE TO BE USED FOR ALL RUBBISH

ON SITE AND RUBBISH REMOVED FROM ENCLOSURE(S) WHEN

#### REQUIRED OR FULL. CUT AND FILL VOLUMES

CUT 1.665m<sup>3</sup> FILL 1,450m<sup>3</sup>

EXCESS SOIL TO BE DISPOSED OF AT AN ENVIRONMENT PROTECTION AUTHORITY APPROVED LOCATION.

## NOISE

ENSURE ALL BUILDING WORK THAT GENERATES NOISE IS CONDUCTED WITHIN THE TIME PERIODS DETAILED IN SCHEDULE 2 OF THE ENVIRONMENT PROTECTION REGULATIONS 2005.

BUILDING WORK DETAILS	MONDAY TO SATURDAY	SUNDAY AND PUBLIC HOLIDAYS
INDUSTRIAL, CITY AND TOWN CENTRE AREAS	6AM TO 8PM	6AM TO 8PM
ANY OTHER AREA WHEN WORK COMPLETED WITHIN 2 WEEKS	7AM TO 6PM	8AM TO 8PM
ANY OTHER AREA WHEN WORK NOT COMPLETED WITHIN 2 WEEKS	7AM TO 6PM	BUILDING WORK MUST NOT EXCEED NOISE STANDARD
IN ADDITION:		

- SCHEDULE NOISY ACTIVITIES FOR THE LEAST SENSITIVE TIMES OF THE DAY SUCH AS MID-MORNING
- AND MID-AFTERNOON. SELECT MACHINERY THAT PRODUCE LESS NOISE; AND ENSURE MACHINERY IS WELL MAINTAINED.

## SEDIMENT CONTROL POND NOTES

#### 1. DISCHARGE FROM THE POND IS PERMISSIBLE WHEN THE WATER pH IS 6.5-8.5 AND IS CLARIFIED TO OR AT BELOW 60mg/L (50NTU). IF SEDIMENT LEVEL IS GREATER, THEN PRIOR TO DISCHARGE, THE DAM MUST BE DOSED WITH EITHER ALUM OR GYPSUM AND ALLOWED TO SETTLE UNTIL THE SEDIMENT IS LESS THAN 60mg/L (50NTU).

- 2. WATER LEVEL TO BE MAINTAINED AT LESS THAN 20% OF CAPACITY TO ALLOW RUNOFF STORAGE DURING A RAIN EVENT. 3. REGULAR DREDGING OF THE DAM MUST BE CARRIED OUT TO REMOVE SILT.
- 4. SITE DRAWING AND DETAILS MUST BE PROVIDED TO ENVIRONMENT PROTECTION AUTHORITY, FOR APPROVAL PRIOR TO WORKS COMMENCING.

ALL WORK IS TO COMPLY WITH ENVIRONMENT PROTECTION GUIDELINES FOR CONSTRUCTION AND LAND DEVELOPMENT IN THE ACT 2011

BURNING OF WASTE MATERIALS ON THE SITE, SUCH AS PLASTICS, CHEMICALS OR WOOD THAT MAY BE PAINTED, CHEMICALLY TREATED OR CONTAMINATED WITH CHEMICALS IS ILLEGAL. A FIRE MAY BE PERMITTED FOR HEATING PURPOSES PROVIDED IT IS IN A BRAZIER OR CONSTRUCTED FIREPLACE. ONLY SEASONED, UNTREATED TIMBER CAN BE BURNED FOR HEATING PURPOSES.

### SEDIMENT CONTROL NOTES

- SEDIMENT AND EROSION CONTROL DEVICES ARE TO BE INSTALLED IN ACCORDANCE WITH 'ENVIRONMENT PROTECTION GUIDELINES FOR CONSTRUCTION AND LAND DEVELOPMENT IN THE ACT" (ENVIRONMENT PROTECTION AUTHORITY MARCH 2011) AND FULLY OPERATIONAL PRIOR TO STRIPPING OF SITE TOP SOIL.
- STOCK PILE/S TO BE LOCATED AWAY FROM DRAINAGE LINES AND SURFACE FLOW PATHS.
- CONTOURED STRIATIONS OR FURROWS TO BE PROVIDED TO STOCK PILES TO MINIMISE EROSION. STABILISED CONSTRUCTION ENTRANCE TO BE CONSTRUCTED PRIOR TO ACCESS TO SITE BY CONSTRUCTION VEHICLES. AGGREGATE TO BE TURNED WHEN SEDIMENT BUILDS UP AND
- RENEWED WHEN REQUIRED. WHERE UNDERGROUND STORMWATER DRAINAGE IS INSTALLED TO INTERNAL ROADWORKS.
- PROVIDE INLET FILTER IN ACCORDANCE WITH GIVEN DETAIL.
- AVERAGE EXISTING SITE SLOPE: 2.3%
- TOTAL SITE AREA: 8120m² ENVIRONMENT PROTECTION AGREEMENT TO BE TAKEN OUT BY BUILDING CONTRACTOR WITH ENVIRONMENT PROTECTION AUTHORITY. (TELEPHONE 132281)
- ALL NEW CONSTRUCTION WORK MUST BE CONTAINED WITHIN THE SITE EXCEPT FOR APPROVED
- SERVICE CONNECTIONS AND ROADWORKS. LIMIT ACCESS TO SITE DURING AND IMMEDIATELY AFTER WET WEATHER.
- REGULARLY REMOVE ANY SOIL FROM ROADS ADJACENT TO THE SITE.
- 11. NO STORAGE OF CONSTRUCTION MATERIALS, PARKING OF VEHICLES NOR EQUIPMENT PERMITTED OUTSIDE OF BLOCK WITHOUT TCCS APPROVAL
- 12. NO SITE SHEDS, STORAGE SHEDS OR SITE AMENITIES TO BE ERECTED OUTSIDE OF BLOCK WITHOUT TCCS APPROVAL.
- 13. PROVIDE KERBSIDE FILTER ROLL TO EXISTING SUMPS WHERE INDICATED, REFER TO GIVEN 14. KERBSIDE FILTER ROLLS TO BE REMOVED, CLEANED AND REINSTATED ON A WEEKLY BASIS AT A MINIMUM. TRAPPED SEDIMENT ABOUT SUMPS ALSO TO BE REMOVED. CLEANING IS ALSO TO
- TAKE PLACE IMMEDIATELY AFTER PERIODS OF RAINFALL DURING CONSTRUCTION. 15. ALL SERVICE TRENCHES TO BE BACK FILLED WITHIN 24 HOURS OF INSPECTION.
- 16. EXCESS SOIL IS TO BE DISPOSED AT AN ENVIRONMENT PROTECTION AUTHORITY APPROVED 17. THE SITE FOREMAN IS TO CONTACT THE ENVIRONMENT PROTECTION AUTHORITY (132281) TO
- ARRANGE A SITE INSPECTION AND ENDORSEMENT OF SEDIMENT AND EROSION CONTROL MEASURES PRIOR TO WORKS COMMENCING. 18. THE SITE FOREMAN IS TO CONTACT THE ENVIRONMENT PROTECTION AUTHORITY (132281) TO
- DISCUSS ANY PROPOSED MAJOR CHANGES TO SEDIMENT AND EROSION CONTROLS ON SITE PRIOR TO IMPLEMENTING THE CHANGES.
- THE SITE FOREMAN IS TO ENSURE CONTRACTOR'S ACCESS AND EXIT THE SITE USING ONLY ENVIRONMENT PROTECTION AUTHORITY APPROVED STABILISED ACCESS/EXIT POINTS AS DETAILED ON ENDORSED SEDIMENT AND EROSION CONTROL PLANS.

## MAINTENANCE SCHEDULE

#### WEEKLY:

CHECK AND REINSTATE SILT CONTROL FENCES.

### DAILY:

SWEEP AND REMOVE DIRT AND ANY OTHER BUILDING MATERIAL FROM GUTTERS, FOOTPATHS AND ROADWAYS ADJACENT TO THE SITE BY CLOSE OF BUSINESS AND PRIOR TO RAIN AND AS REQUIRED. ALL NECESSARY STEPS SHOULD BE TAKEN THAT ARE PRACTICAL AND REASONABLE TO MINIMISE DUST POLLUTION.

#### DURING/AFTER WET WEATHER:

LIMIT CONSTRUCTION VEHICLE ACCESS TO SITE DURING AND IMMEDIATELY FOLLOWING WET WEATHER CHECK AND REINSTATE SEDIMENT EROSION CONTROL MEASURES AND CHECK ROAD.

### DUST MANAGEMENT

WHERE BUILDING WORK GENERATES DUST, ALL REASONABLE AND PRACTICABLE MEASURES SHOULD BE TAKEN TO MINIMISE THAT DUST.

#### THIS CAN OFTEN BE ACHIEVED BY

- RETAINING EXISTING VEGETATION WHERE POSSIBLE
- STRIPPING AREAS PROGRESSIVELY AND ONLY WHERE IT IS NECESSARY FOR WORKS TO
- EMPLOYING STABILISING METHODS SUCH AS MATTING, GRASSING OR MULCH
- DAMPENING THE GROUND WITH A LIGHT WATER SPRAY (CONTACT THE ENVIRONMENT PROTECTION AUTHORITY FOR REQUIREMENTS DURING EXTREME DROUGHT CONDITIONS)
- ROUGHENING SURFACE OF EXPOSED SOIL COVERING STOCKPILES AND LOCATING THEM WHERE THEY ARE PROTECTED FROM THE
- RESTRICTING VEHICLE MOVEMENTS
- COVERING THE LOAD WHEN TRANSPORTING MATERIAL
- CONSTRUCTING WIND BREAKS SUCH AS WIND FENCES IN ACCORDANCE WITH THE BLUE
- A WATER CART OR SUFFICIENT WATER SPRAYS SHALL BE MADE AVAILABLE AT ALL TIMES. IN ADVERSE CONDITIONS WHEN DUST CANNOT BE ADEQUATELY CONTROLLED WHEN WORKS ARE BEING UNDERTAKEN, WORKS WILL CEASE IN THESE AREAS UNTIL CONDITIONS
- WATER SHALL BE APPLIED TO SUPPRESS DUST FROM OPEN EARTHWORKS AS WELL AS UNPROTECTED STOCKPILES
- AREAS OF COMPLETED EARTHWORKS SHALL BE PROGRESSIVELY REHABILITATED WITH DRYLAND GRASS AND FENCED OFF AS SOON AS PRACTICABLE TO PREVENT FURTHER
- THE CONTRACTOR SHALL CONTACT ICON WATER TO OBTAIN RECYCLED WATER FROM THE LOWER MOLONGLO
- THE CONTRACTOR IS TO CONTACT THE WATER RESOURCES UNIT TO OBTAIN AN
- EXEMPTION TO USE NON-POTABLE WATER FROM ON OR OFF THE SITE IF REQUIRED DURING WINDY CONDITIONS, THE CONTRACTOR IS TO MINIMISE DUST GENERATING ACTIVITIES AND REGULARLY APPLY DUST SUPPRESSING MEASURES. IF DUST SUPPRESSION

MEASURES FAIL THE CONTRACTOR IS TO CEASE DUST GENERATING ACTIVITIES

### DISPOSAL OF SPOIL

PRIOR TO ANY WORKS COMMENCING INVOLVING EXPORT OF SPOIL GREATER THAN 100m3, THE FOLLOWING INFORMATION MUST BE PROVIDED TO THE ENVIRONMENT PROTECTION AUTHORITY VIA EMAIL (environment.protection@act.gov.au):

- WHERE THE SPOIL WILL ORIGINATE FROM: WHO IS DISPOSING OF THE SPOIL: WHERE THE SPOIL WILL BE TAKEN: THE AMOUNT OF SPOIL TO BE TAKEN AWAY
- MOVEMENT DATES AND CONTACT DETAILS: DESCRIPTION OF THE TYPE OF SPOIL TAKEN AWAY:DETAILS OF HOW RECORDS WILL BE KEPT; AND
- TIME FRAME TO COMPLETE THE WORKS TO THE SATISFACTION OF THE ENVIRONMENT PROTECTION AUTHORITY.

SPOIL MAY BE TAKEN TO AN APPROVED LANDFILL SITE WITHOUT APPROVAL. IF THE SPOIL IS TO BE TAKEN TO AN AREA OTHER THAN APPROVED LANDFILL SITE, ENSURE THE ACCEPTOR OF THE SPOIL IS AWARE OF THE REQUIREMENTS SETOUT IN SECTION 8.2 OF THE ENVIRONMENT PROTECTION GUIDELINES FOR CONSTRUCTION AND LAND DEVELOPMENT IN THE ACT.

### ON-SITE MANAGEMENT OF VERGES AND OPEN SPACE

- BEFORE COMMENCING WORKS, THE COORDINATOR SHALL ADVISE ASSET ACCEPTANCE (AA) IN WRITING THAT THE PROTECTIVE MEASURES HAVE BEEN INSTALLED IN ACCORDANCE WITH THE APPROVED LANDSCAPE MANAGEMENT PROTECTION PLAN (LMPP). RANDOM AUDITS WILL BE UNDERTAKEN BY AA TO ENSURE
- COMPLIANCE: FAILURE TO COMPLY MAY INCUR THE ISSUE OF A STOP WORK NOTICE. ALL WORKS SHALL BE CONTAINED WITHIN THE AUTHORISED SITE EXCEPT FOR APPROVED SERVICE CONNECTIONS IN THE VERGE OR OTHER APPROVED.
- **EXCEPTIONS** DURING THE PROGRESS OF THE WORKS ALL EXISTING VERGE GRASS COVER SHALL BE MAINTAINED IN ITS PRE-EXISTING CONDITION. PROTECTIVE MEASURES
- SHALL INCLUDE REGULAR WATERING TO MAINTAIN GRASS AND TREES IN GOOD CONDITION. WHERE THE SURFACE IS GRASS OR BARE SOIL WITHOUT TREES, NO PROTECTION IS REQUIRED. WHERE TOPSOIL AND GRASS OR OTHER APPROVED SURFACES,
- ARE INSTALLED AT THE COMPLETION OF THE WORKS IN ACCORDANCE WITH THE "STANDARD SPECIFICATION FOR URBAN INFRASTRUCTURE WORKS".
- FOR ALL WORKS, OTHER THAN MINOR WORKS (I.E. MINOR IN COMPLEXITY AND/OR SCOPE OF WORKS AND CONFIRMED AS MINOR WORKS BY AA), AND UNLESS OTHERWISE APPROVED BY AA, A SUITABLY QUALIFIED LANDSCAPE ARCHITECT OR HORTICULTURIST SHALL BE EMPLOYED TO ENSURE THAT THE WORK IN THE VERGE MEETS THE REQUIREMENTS. THE ARCHITECT/HORTICULTURIST SHALL ALSO BE PRESENT DURING ANY CULTIVATION OR RESTORATION OF THE VERGE WHICH AFFECTS PLANT MATERIAL AND SHALL PROVIDE CERTIFICATION. ENDORSED BY THE COORDINATOR. THAT ALL WORK, CULTIVATION AND RESTORATION
- HAVE BEEN PERFORMED TO INDUSTRY STANDARDS. 3 STORAGE OF CONSTRUCTION MATERIALS
- THE STORAGE OF CONSTRUCTION MATERIALS AND THE PARKING OF VEHICLES OR EQUIPMENT ON VERGES OR ADJACENT PUBLIC OPEN SPACES ARE NOT PERMITTED WITHOUT PRIOR APPROVAL FROM TCCS. WHERE THERE IS NO ALTERNATIVE AVAILABLE OTHER THAN TO USE THESE AREAS FOR STORAGE AND/OR PARKING. THE COORDINATOR MAY LODGE AN APPLICATION WITH THE LMPP REQUESTING APPROVAL FOR THE USE OF THESE AREAS FOR THE DESIGNATED PURPOSES. APPROVAL MAY BE GIVEN BY TCCS SUBJECT TO CERTAIN TERMS AND CONDITIONS OF USE.
- SITE ACCOMMODATION
- GENERALLY. SITE SHEDS. STORAGE SHEDS. SITE AMENITIES OR BILLBOARDS ARE NOT TO BE ERECTED ON VERGES OR PUBLIC OPEN SPACES WITHOUT PRIOR APPROVAL. SHOULD THERE BE NO ALTERNATIVE, THE COORDINATOR MAY LODGE AN APPLICATION WITH THE LMPP REQUESTING APPROVAL TO ERECT SUCH A STRUCTURE ON THE AREA. THE ERECTION OF SITE ACCOMMODATION MAY BE APPROVED SUBJECT TO THE COORDINATOR'S AGREEMENT TO COMPLY WITH THE TERMS AND CONDITIONS SPECIFIED BY AA AND OBTAINING A PERMIT UNDER THE ROADS AND PUBLIC PLACES ACT 1937 FROM TCCS PCL.
- 5 PROTECTIVE FENCING

- 5.1 EXTENT ALL TEMPORARY PROTECTIVE FENCES ERECTED TO PROTECT EXISTING ASSETS SHALL BE IN ACCORDANCE WITH THE APPROVED LMPP DRAWING. FENCING SHALL BE ERECTED BEFORE THE COMMENCEMENT OF ANY SITE WORKS AND REMOVED AT THE COMPLETION OF ALL CONSTRUCTION ACTIVITY EXCEPT DURING VERGE RESTORATION. THE FENCE SHALL REMAIN IN PLACE THROUGHOUT THE CONSTRUCTION PERIOD.
- EXISTING TREES, PLANTINGS AND GRASS SHALL BE FENCED OFF TO ENCLOSE THE STREET VERGE, PUBLIC OPEN SPACE OR UNLEASED TERRITORY LAND AREA. UNLESS OTHERWISE APPROVED BY AA, PROTECTIVE FENCING SHALL BE LOCATED:
- \* ALONG THE DRIP-LINE OF EACH TREE (AS A MINIMUM), AND \* 1.2M FROM THE BACK OF THE KERB FOR THE FULL FRONTAGE OF THE LEASE, ALONG THE PROPERTY BOUNDARY AND ALONG THE APPROVED DRIVEWAY
- ACCESS TO ENSURE THAT THE VERGE IS COMPLETELY ENCLOSED • 5.2 MATERIALS
- USE OF TEMPORARY 1800MM TALL CONTINUOUS MESH FENCE SUPPORTED BY STEEL POSTS WITH CONCRETE BASES, OR PREFABRICATED FENCING PANELS WITH CONCRETE BASES, IS MANDATORY. ANY VARIATION FROM THIS REQUIREMENT SHALL BE ACCOMPANIED BY WRITTEN APPROVAL FROM AA.
- 5.3 PEDESTRIAN AND TRAFFIC CONSIDERATIONS • EXISTING VERGE FOOTPATHS SHALL BE MAINTAINED. ALL EXISTING VERGE FOOTPATHS AND DRIVEWAYS SHALL REMAIN UNOBSTRUCTED THROUGHOUT THE CONSTRUCTION PERIOD TO PROVIDE SAFE PEDESTRIAN MOVEMENT AT ALL TIMES UNLESS AN ALTERNATIVE IS APPROVED BY TCCS.
- WHERE A CONSTRUCTED FOOTPATH OR CYCLEWAY EXISTS WITHIN THE VERGE, PROTECTIVE FENCING INCLUDING THE CONCRETE PEDESTALS SHALL BE ERECTED TO PROVIDE A CLEAR AND UNOBSTRUCTED SET BACK OF 0.6M FROM EACH SIDE OF THE FOOTPATH/CYCLEWAY IN ALL CASES TO ENSURE SAFE PASSAGE FOR CYCLISTS AND PEDESTRIANS.
- IF THERE IS NO CONSTRUCTED PUBLIC FOOTPATH ON THE VERGE A FENCED CLEARWAY OF 1.8M IN WIDTH SHALL BE MAINTAINED FOR THE ENTIRE FRONTAGE OF THE LEASE TO ALLOW FOR CYCLISTS AND PEDESTRIANS.
- ANY DEVIATIONS FROM THE DISTANCES SPECIFIED IN THIS CLAUSE DEEMED NECESSARY BECAUSE OF LOCAL RESTRAINTS REQUIRE PRIOR APPROVAL FROM AA. ACCESS GATES INTO THE SITE SHALL SWING INTO THE SITE AND NOT BE CAPABLE OF BLOCKING PEDESTRIAN ACCESS ALONG THE VERGE OR VEHICULAR

#### TRAFFIC ON THE ROAD. 5.4 ACCESS FOR SERVICE INSTALLATIONS

- FENCING SHALL NOT BE REMOVED FOR SERVICE INSTALLATION ACROSS THE VERGE WITHOUT PRIOR APPROVAL FROM AA FOR THE SERVICE INSTALLATION. WHERE APPROVAL HAS BEEN GRANTED. THE FENCE SHALL BE REALIGNED TO PROVIDE A LANE FOR SERVICE TRENCHING BUT FENCES SHALL BE RE-ERECT TO ENCLOSE TREES BEFORE TRENCHING COMMENCES. UPON COMPLETION OF TRENCHING. THE FENCE SHALL BE RETURNED TO ITS ORIGINAL ALIGNMENT.
- 6 EXISTING TREES 6.1 GENERAL
- ALL TREES LOCATED IN THE ROAD RESERVE, VERGE, PUBLIC OPEN SPACE AND ON UNLEASED TERRITORY LAND, SHALL BE RETAINED AND MUST REMAIN UNDAMAGED. THE LMPP PROCESS REQUIRES THE COORDINATOR TO IDENTIFY ANY TREES THAT MAY BE AFFECTED BY THE WORKS AND TO SUBMIT A REQUEST. FOR APPROVAL TO PROCEED WITH THE WORK CLEARLY IDENTIFYING THE NATURE OF THE WORK AFFECTING THE TREE AND PROTECTIVE MEASURES PROPOSED TO MINIMISE DAMAGE TO THE TREE. WRITTEN AUTHORISATION FROM AA IS REQUIRED PRIOR TO ANY WORK AFFECTING THE TREE TAKING PLACE.
- AUTHORISATION WILL BE SUBJECT TO: \* EXISTING CANOPY CLEARANCE NOT BEING ALTERED:
- \* CROWNS AND APEX OF CANOPIES NOT BEING ALTERED OR REDUCED; \* LIFTING EQUIPMENT AND LOAD CAPABLE OF OPERATING IN A MANNER THAT IT CLEARS THE HEIGHT AND WIDTH OF THE TREE CANOPY WITHOUT
- DAMAGING THE CROWN, AND \* CONSTRUCTION EQUIPMENT CAN PASS BENEATH THE TREES' LOWEST LIMB THROUGH THE DESIGNATED DRIVEWAY ACCESS ROUTE.
- 6.2 TREE ROOT PROTECTION
- THE MAJORITY OF TREE ROOTS GROW IN THE TOP 300MM OF SOIL. THESE ARE THE FEEDER ROOTS, OFTEN VERY FINE ROOTS THAT PROVIDE THE TREE WITH WATER OXYGEN AND NUTRIENTS. THESE ROOTS TYPICALLY GROW FROM THE TRUNK OF THE TREE TO WELL BEYOND ITS 'DRIP-LINE' (THE CANOPY EDGE). EXCAVATION WITHIN THE DRIP ZONE OF A TREE DOES CONSIDERABLE DAMAGE TO ITS ROOT SYSTEM. IT CAN AFFECT TREE STABILITY AND TREE HEALTH TO
- SUCH AN EXTENT THAT IT WILL LEAD TO THE DECLINE AND POSSIBLE DEATH OF THE TREE OVER A PERIOD OF YEARS.
- EXCAVATION THAT OCCURS WITHIN THE DRIP ZONE OF A TREE SHALL BE RESTRICTED TO ONE SIDE OF THE TREE ONLY AND SHALL HAVE PRIOR APPROVAL WHERE EXCAVATION IS APPROVED. THE FOLLOWING MEASURES SHALL BE ADOPTED FOR TREE PROTECTION:
- \* DO NOT SEVER LARGE ROOTS (>30MM DIAMETER) CLOSER THAN HALFWAY FROM THE DRIP-LINE TO THE TRUNK \* LOCATE THESE ROOTS BY HAND TRENCHING TO A DEPTH OF 300MM BEFORE ANY MECHANICAL TRENCHING IS UNDERTAKEN;
- \* CUT ALL ROOTS CLEANLY WITH EQUIPMENT SPECIFICALLY DESIGNED FOR THIS PURPOSE OR BY SUITABLE PRUNING EQUIPMENT: \* PROTECT ROOTS EXPOSED FROM DESICCATION BY LIGHTLY WATERED OR COVERING WITH HESSIAN, WHICH MUST BE KEPT MOIST, AND \* MAINTAIN THE GOOD HEALTH OF THE TREES THAT HAVE HAD DISTURBANCE IN THEIR ROOT ZONE BY CONTINUAL WATERING, AT NO TIME SHALL THE
- DISTURBED AREA BE ALLOWED TO DRY OUT TO THE DETRIMENT OF THE TREES HEALTH. 7 SITE ACCESS
- SITE ACCESS SHALL BE BY THE EXISTING DRIVEWAY ACCESS POINTS FOR THE WORKS. IN SOME CASES CONSIDERATION MAY BE GIVEN TO ALLOWING NEW ACCESS POINTS ACROSS PUBLIC LAND, HOWEVER, ALTERNATIVE OR ADDITIONAL ACCESS POINTS REQUIRE APPROVAL FROM AA. WHERE APPROVAL HAS BEEN GRANTED, THE SITE ACCESS SHALL BE POSITIONED MIDWAY BETWEEN TWO EXISTING TREE
- TRUNKS DEPENDENT ON THE DISTANCE BETWEEN TREES. ACCESS SHALL NOT OCCUR ON TWO SIDES OF A TREE WITHIN THE APPROVED CLEARANCE DIMENSION. CONSTRUCTION TECHNIQUE SHALL MINIMISE THE NEED FOR EXCAVATION ACROSS THE VERGE.
- ACCESS ACROSS ADJOINING PUBLIC OPEN SPACES, PARKS, RECREATIONAL RESERVES, ADJOINING PROPERTIES E.G. SCHOOL PLAYGROUNDS, COMMUNITY HALLS ETC, IS PROHIBITED WITHOUT PRIOR WRITTEN AUTHORISATION FROM TCCS, AND ANY OTHER ASSET OWNER WHERE APPLICABLE.
- 8 SERVICES AND UTILITIES
- 8.1 SERVICE CONNECTION TO SITE
- THE COORDINATOR SHALL COORDINATE AND COLLATE ALL APPROVALS FOR PROPOSED SERVICES WITHIN THE AREA. APPROVAL FOR TRENCH LOCATIONS AND EXCAVATIONS WITHIN THE VERGE SHALL BE OBTAINED THROUGH THE RELEVANT TCCS AGENCIES AT THE PLANNING. AND DESIGN STAGES. APPROVAL IS SUBJECT TO THE FOLLOWING REQUIREMENTS: \* IF THE PROPOSED EXCAVATION IS WITHIN THE CANOPY SPREAD OF ANY TREE, BORING OR TUNNELING BELOW THE ROOT ZONE MUST BE UNDERTAKEN;
- \* SHARED TRENCHING FOR SERVICES IS MANDATORY: \* THE NUMBER OF VERGE CROSSINGS SHALL BE MINIMISED \* EXCAVATION FOR SERVICES ACROSS VERGE (I.E. AT RIGHT ANGLES TO KERB OR PROPERTY LINE) SHALL BE MIDWAY BETWEEN THE TREE TRUNKS

\* ANY SERVICE INSTALLATION WITHIN 5.0M OF AN EXISTING TREE TRUNK, OR WITHIN THE TREE CANOPY, REQUIRES PRIOR APPROVAL.

- 8.2 SERVICES AND UTILITIES ALONG ROAD RESERVES THE COORDINATOR SHALL COORDINATE ALL SERVICE APPROVALS: APPROVAL BY AA FOR TRENCH LOCATIONS SHALL BE OBTAINED AS PART OF THE LMPP
- TO MINIMISE DAMAGE AND/OR DISTURBANCES TO THE ROOTS OR ROOT ZONE AND SUBJECT TO APPROVAL BY AA, ANY NEW OR UPGRADED SERVICES PARALLEL TO THE KERB OR PROPERTY LINE SHALL BE INSTALLED ON THE FOLLOWING ALIGNMENTS: \* WITHIN ROAD PAVED AREA:
- \* BELOW THE ROOT ZONE IF THE EXCAVATION REQUIRED IS WITHIN THE CANOPY SPREAD OF ANY TREE;
- \* BELOW THE EXISTING FOOTPATH ON THE PROPERTY LINE, AND \* IMMEDIATELY BEHIND THE KERB.
- 9 IRRIGATION
- PARKS CONSERVATION AND LANDS (PCL) ACTIVELY DISCOURAGES THE USE OF IN-GROUND IRRIGATION SYSTEMS AND GENERALLY DOES NOT ENDORSE THEIR INSTALLATION IN THE VERGE. HOWEVER, A SYSTEM OF QUICK-COUPLERS AT THE LEASE EDGE OF THE VERGE MAY BE INSTALLED SUBJECT TO APPROVAL OF THE IRRIGATION PLAN BY PCL. A PREFERRED ALTERNATIVE IS THE PLANTING OF DROUGHT TOLERANT GRASSES AND SHRUBS THAT ARE NOT RELIANT ON WATERING TO SURVIVE.
- 10 VERGE INFRASTRUCTURE CONDITION AND RESTORATION
- THE COORDINATOR SHALL NOTIFY AA AT THE COMPLETION OF WORK AND OBTAIN APPROVAL PRIOR TO COMMENCEMENT OF ANY VERGE RESTORATION. DURING VERGE RESTORATION, TOPSOIL SHALL NOT BE REMOVED AND THE SOIL LEVEL SHALL NOT BE CHANGED WITHIN THE DRIP ZONE OF TREES OR AS OTHERWISE APPROVED AND, UPON COMPLETION OF THE WORKS, VERGES SHALL HAVE ESTABLISHED APPROPRIATE GRASS COVER AS APPROVED BY PCL, E.G. DRYLAND GRASS, NATIVE GRASS OR COUCH.
- IF THE STANDARD OF GRASS COVER ON THE VERGE NEEDS TO BE IMPROVED, THE FOLLOWING REQUIREMENTS SHALL APPLY: \* WITHIN THE ROOT ZONE OF TREES, LIGHTLY CULTIVATE THE SOIL IN ONE DIRECTION ONLY TO BETWEEN 25MM TO 50MM DEPTH (50MM MAXIMUM TO MINIMISE DAMAGE TO TREE ROOTS). AVOID MAJOR ROOTS AND KEEP A MINIMUM OF 1M AWAY FROM TREE TRUNKS:
- \* OUTSIDE THE ROOT ZONE OF TREES NORMAL CULTIVATION PRACTICE APPLIES; \* ADD 'B TYPE' TOPSOIL AT 25MM TO 50MM DEPTH. LEVEL THE TOPSOIL AND ADD NPK FERTILISER (EQUIVALENT TO MULTIGRO) AT 40G/M². AND \* LAY TURF OR SOW SEED OF SUITABLE DROUGHT TOLERANT SPECIES AS SPECIFIED IN THE STANDARD SPECIFICATION FOR URBAN INFRASTRUCTURE WORKS.
- ALL RESTORATION WORK SHALL BE APPROVED BY AA AND CARRIED OUT BY APPROVED OPERATORS.

DESIGNED BY DRAWING TITLE SCALE PIALLIGO VILLAGE AND ANIMAL SITE ESTABLISHMENT AM CHECKED BY REFERENCE HOSPITAL NOTES & DETAILS CO PROJECT LOCATION AUTHORISED BY DO NOT SCALE OFF DRAWINGS JOB NO. DRAWING NO. REV. BLOCK 17 SECTION 2 VERIFY ALL DIMENSIONS ON SITE BEFORE COMMENCING WORK. C103 COPYRIGHT: The concepts and information contained in this document are copyright of Sellick DATE 02 6201 0200 www.sellickconsultants.com.au PIALLIGO, ACT Consultants. Use or copying of this document in whole or in part without written permission constitutes an infringement of copyright.

sellick consultants STRUCTURAL CIVIL HYDRAULIC canberra sydney brisbane

KEEP MOIST DURING ESTABLISHMENT.

01/02/2019

FOR DESIGN ACCEPTANCE REVISED FOR WORKS APPROVAL FOR WORKS APPROVAL FOR REVIEW ISSUE DESCRIPTION

REVISED FOR WORKS APPROVAL

FOR DESIGN ACCEPTANCE

04.08.17 21.07.17 DATE

29.03.18 05.10.17 NS AM


01.02.19


22.05.18


DRAWN


TURCO AND ASSOCIATES


DR JACOB MICHELSEN

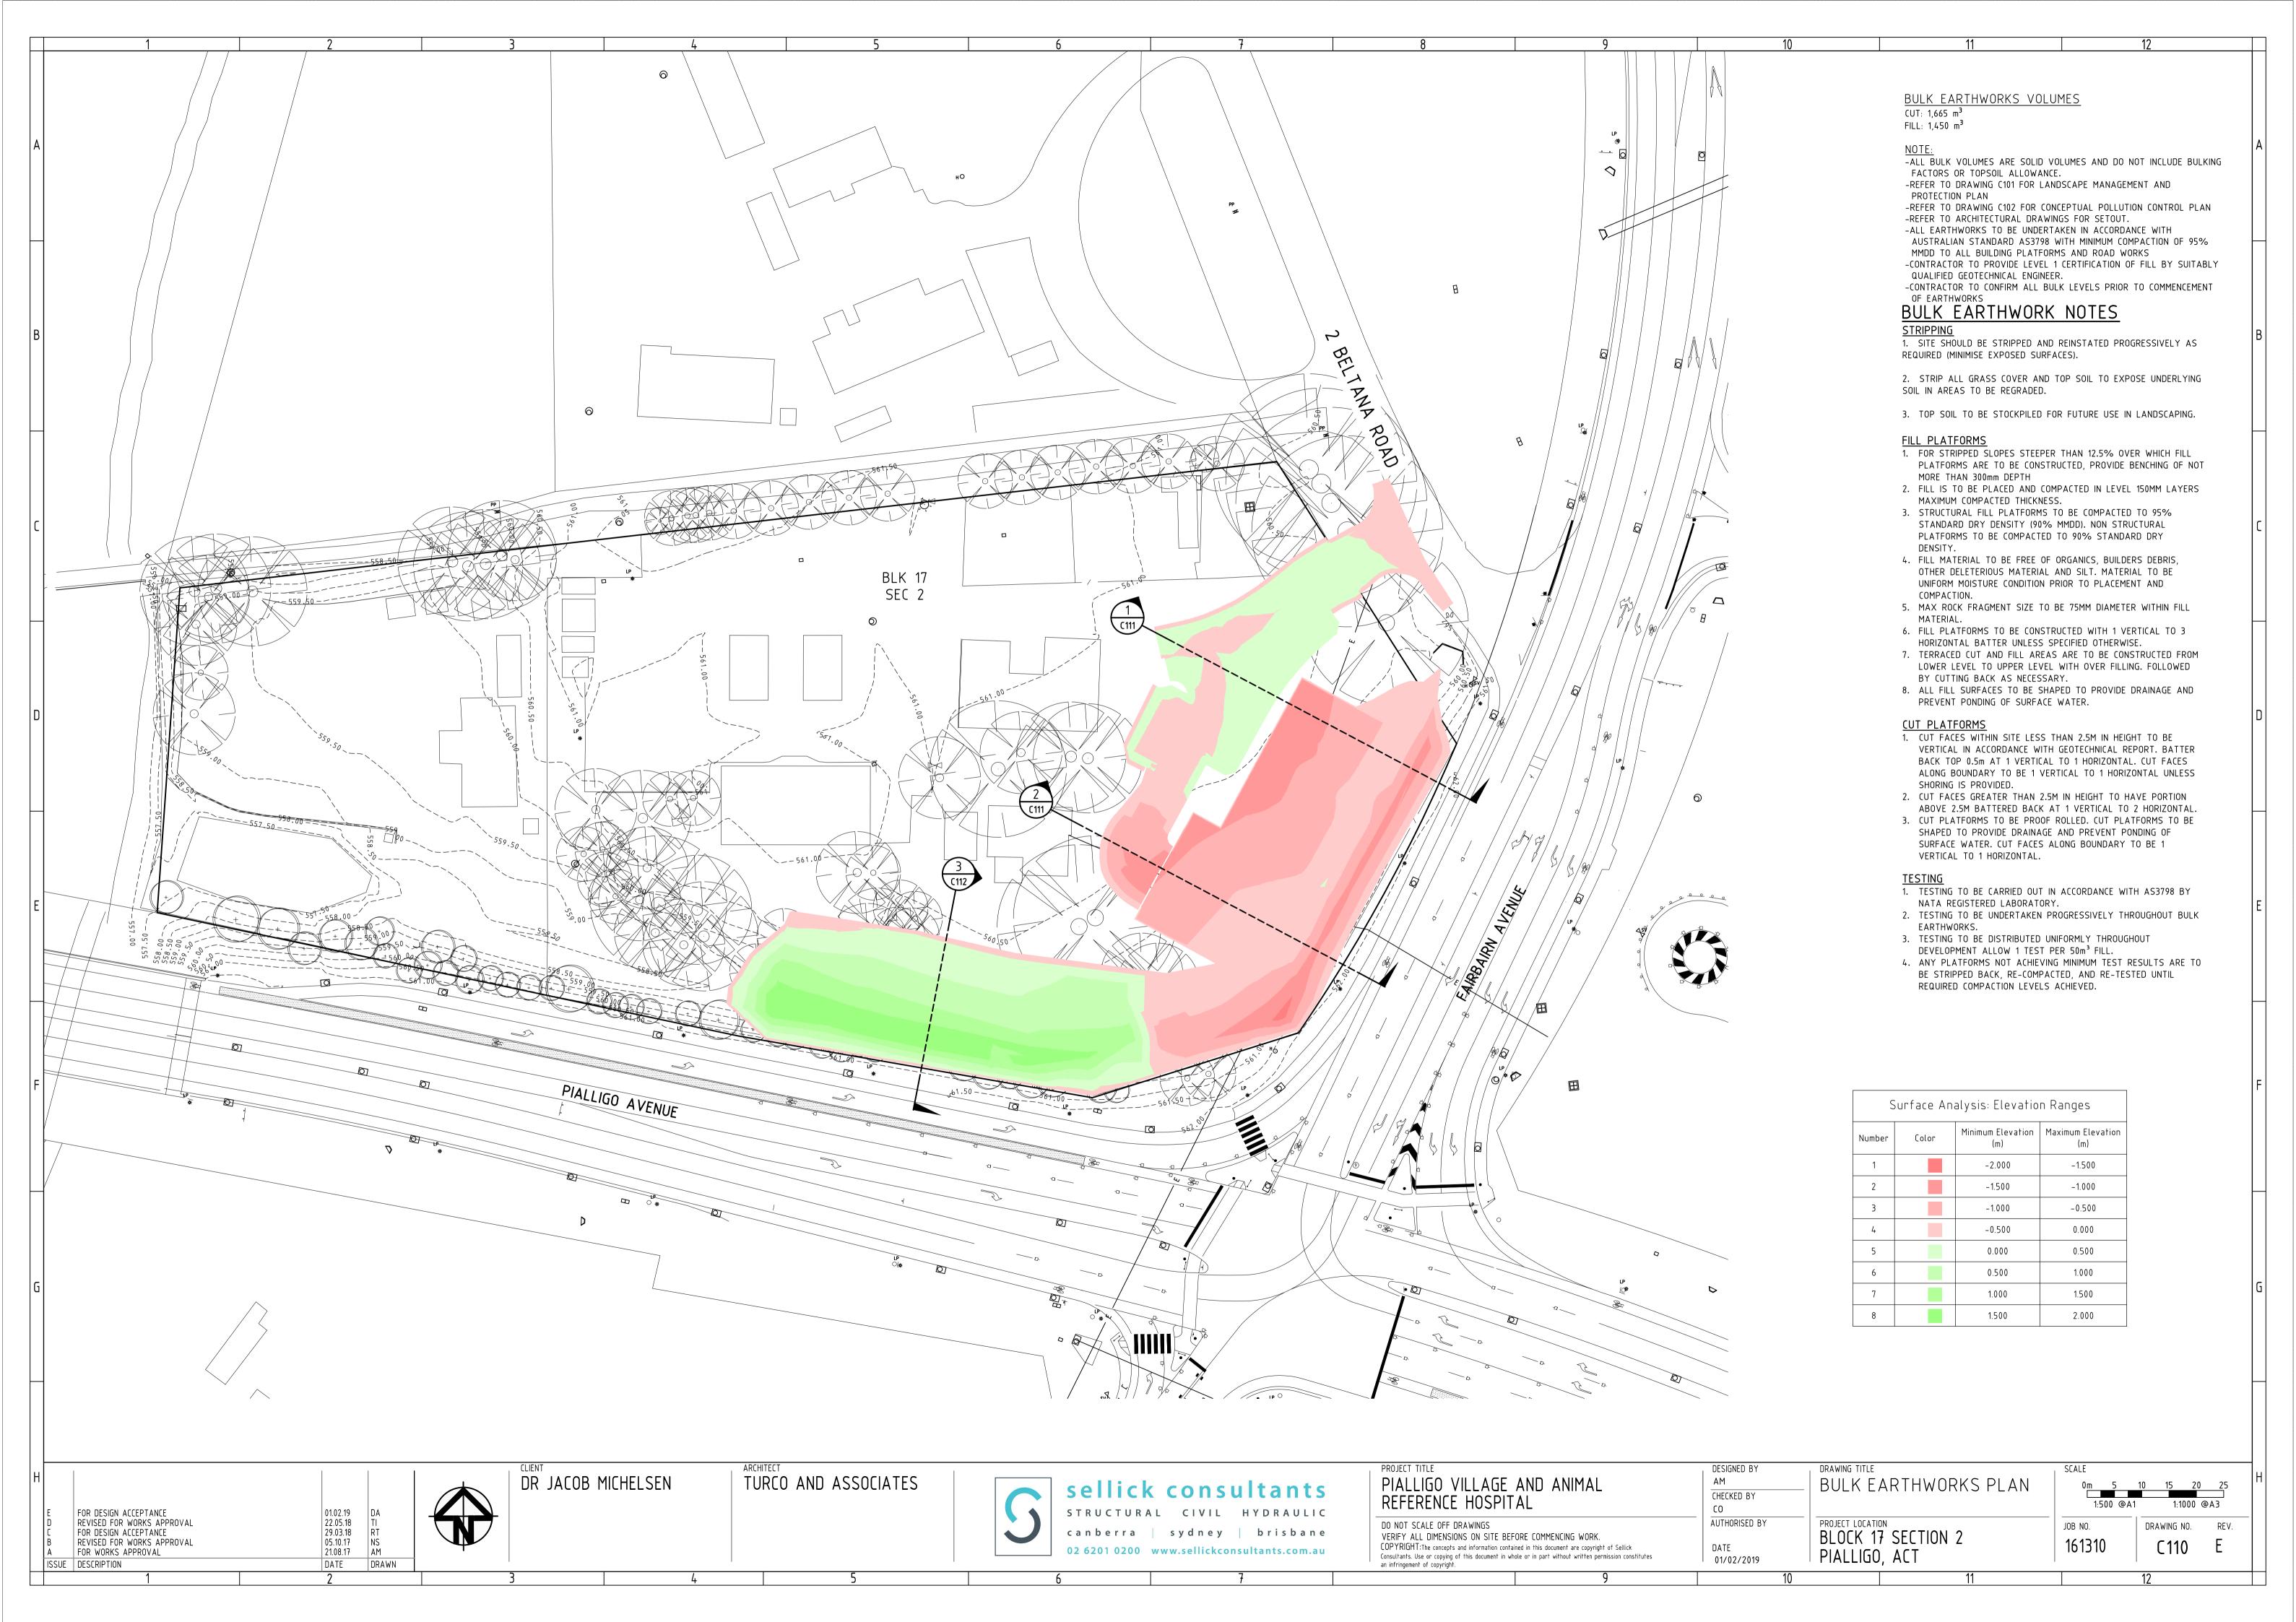


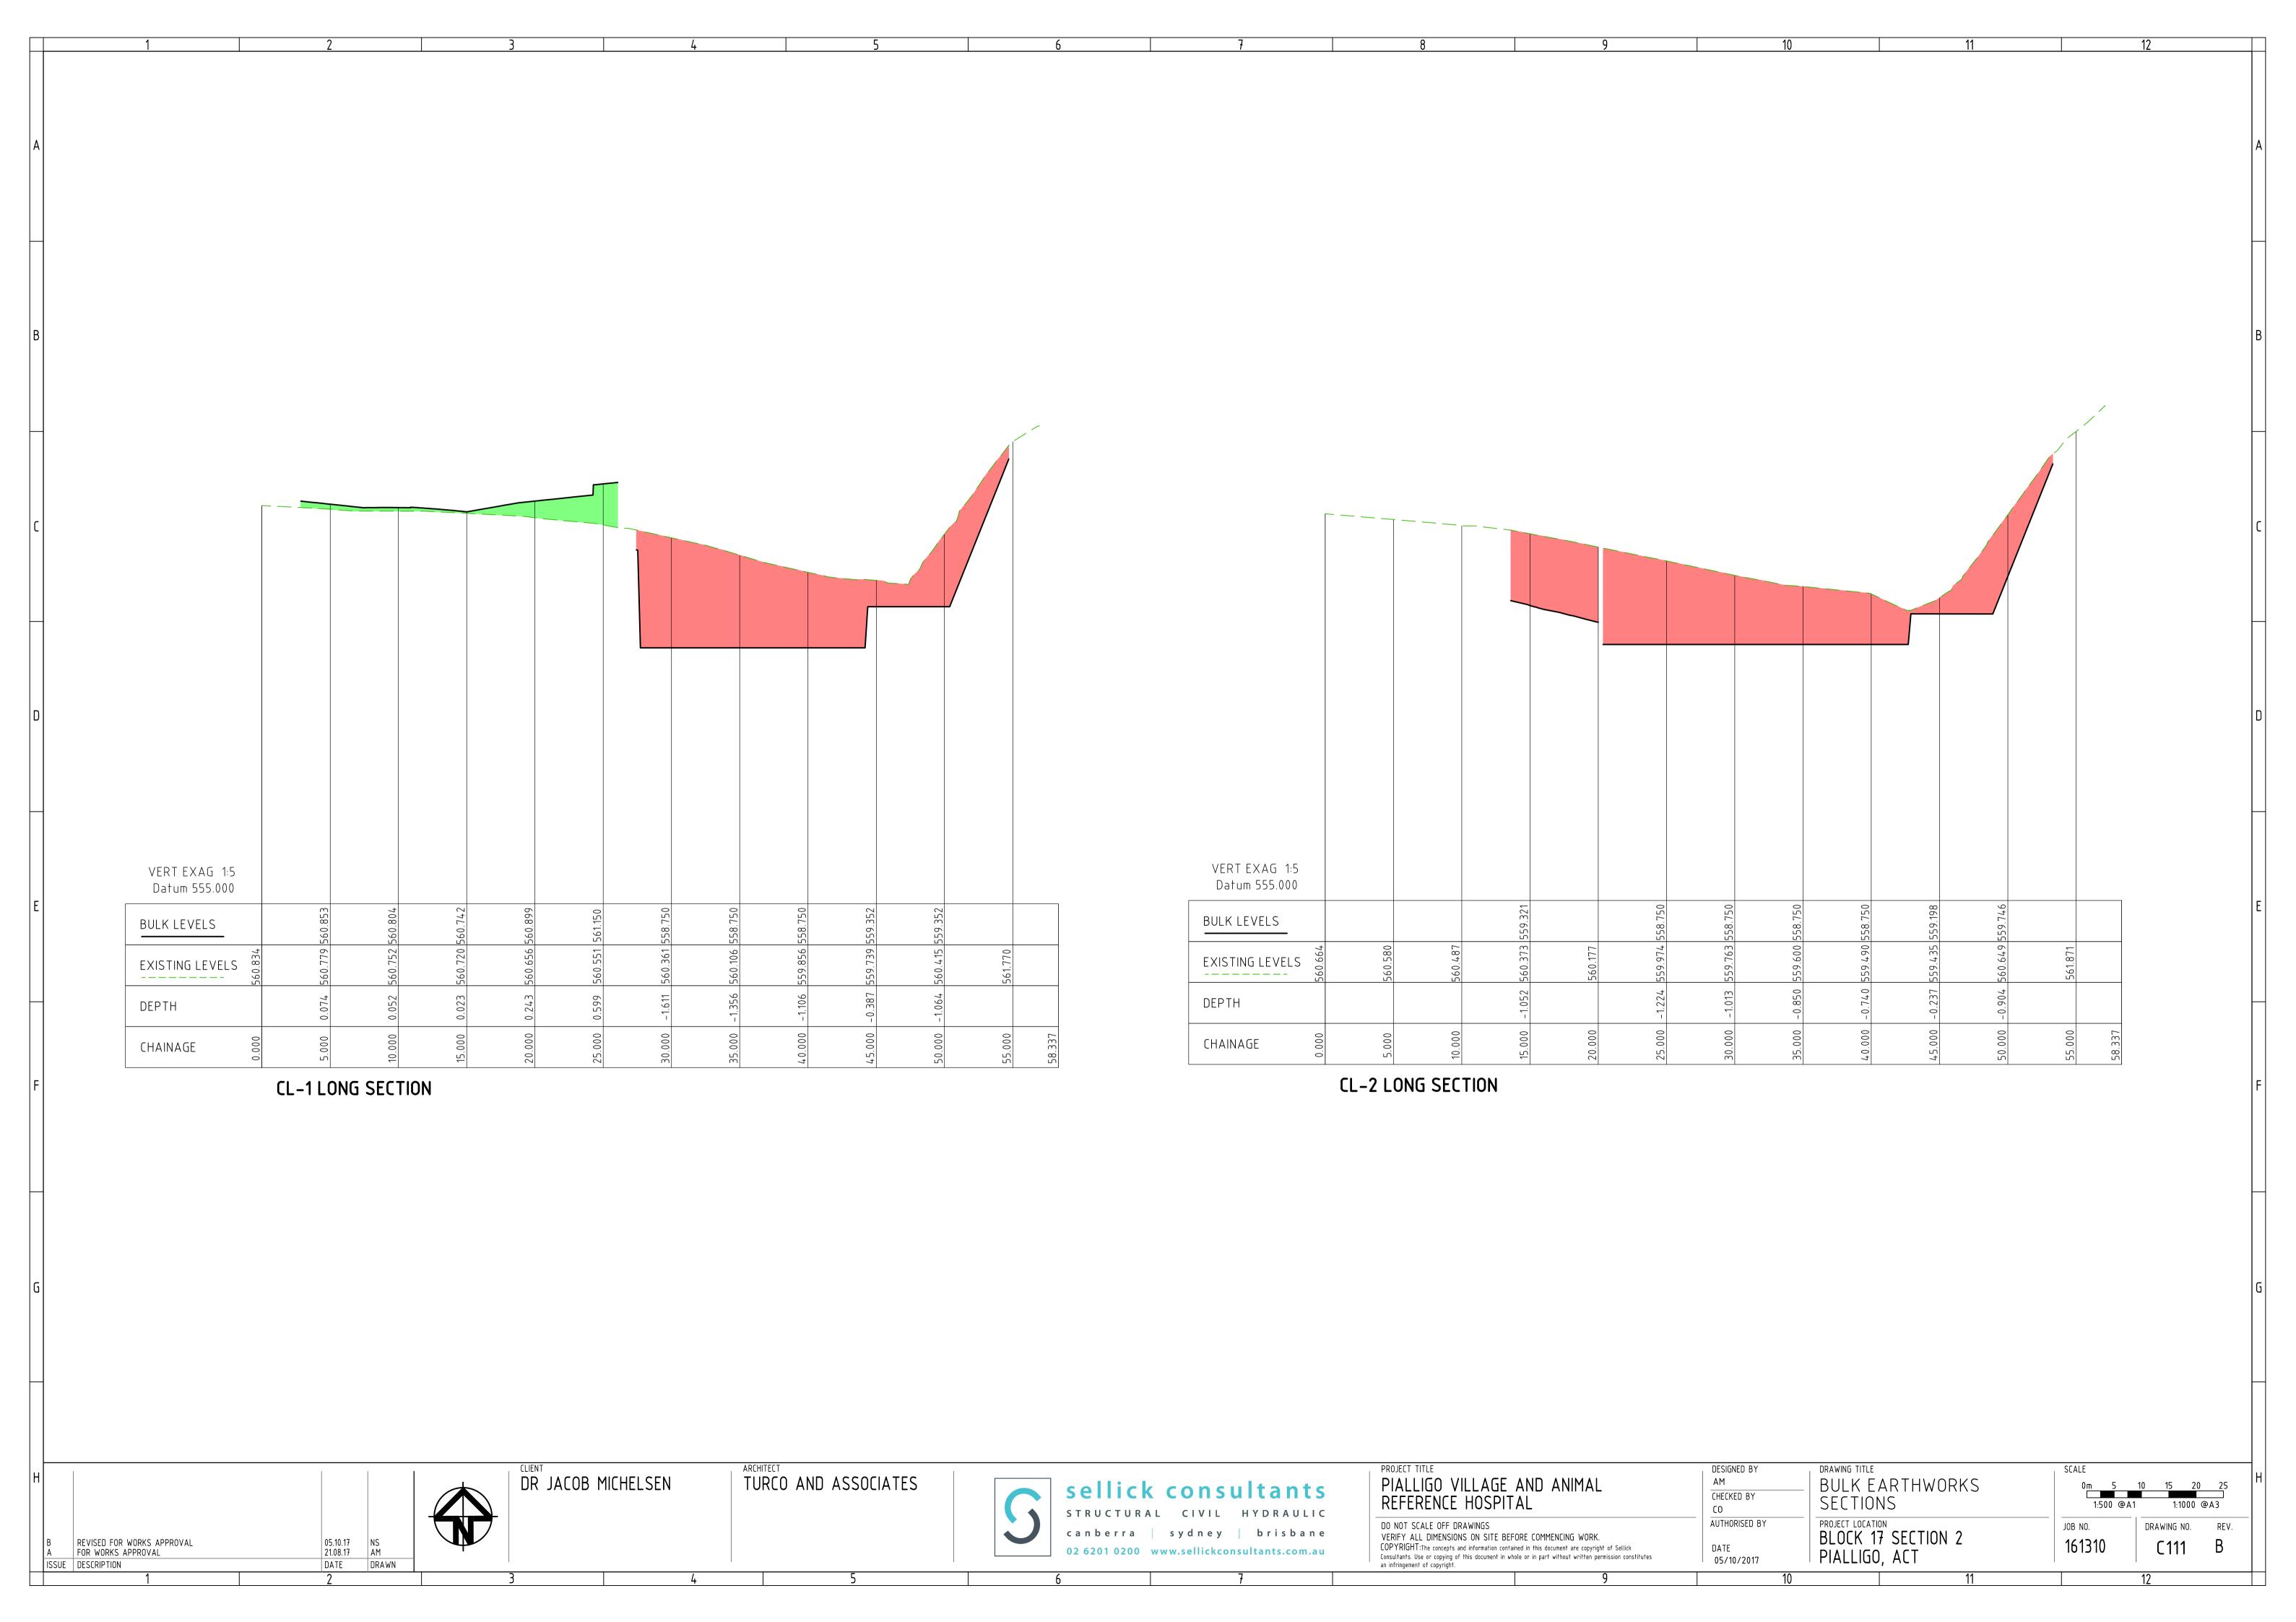

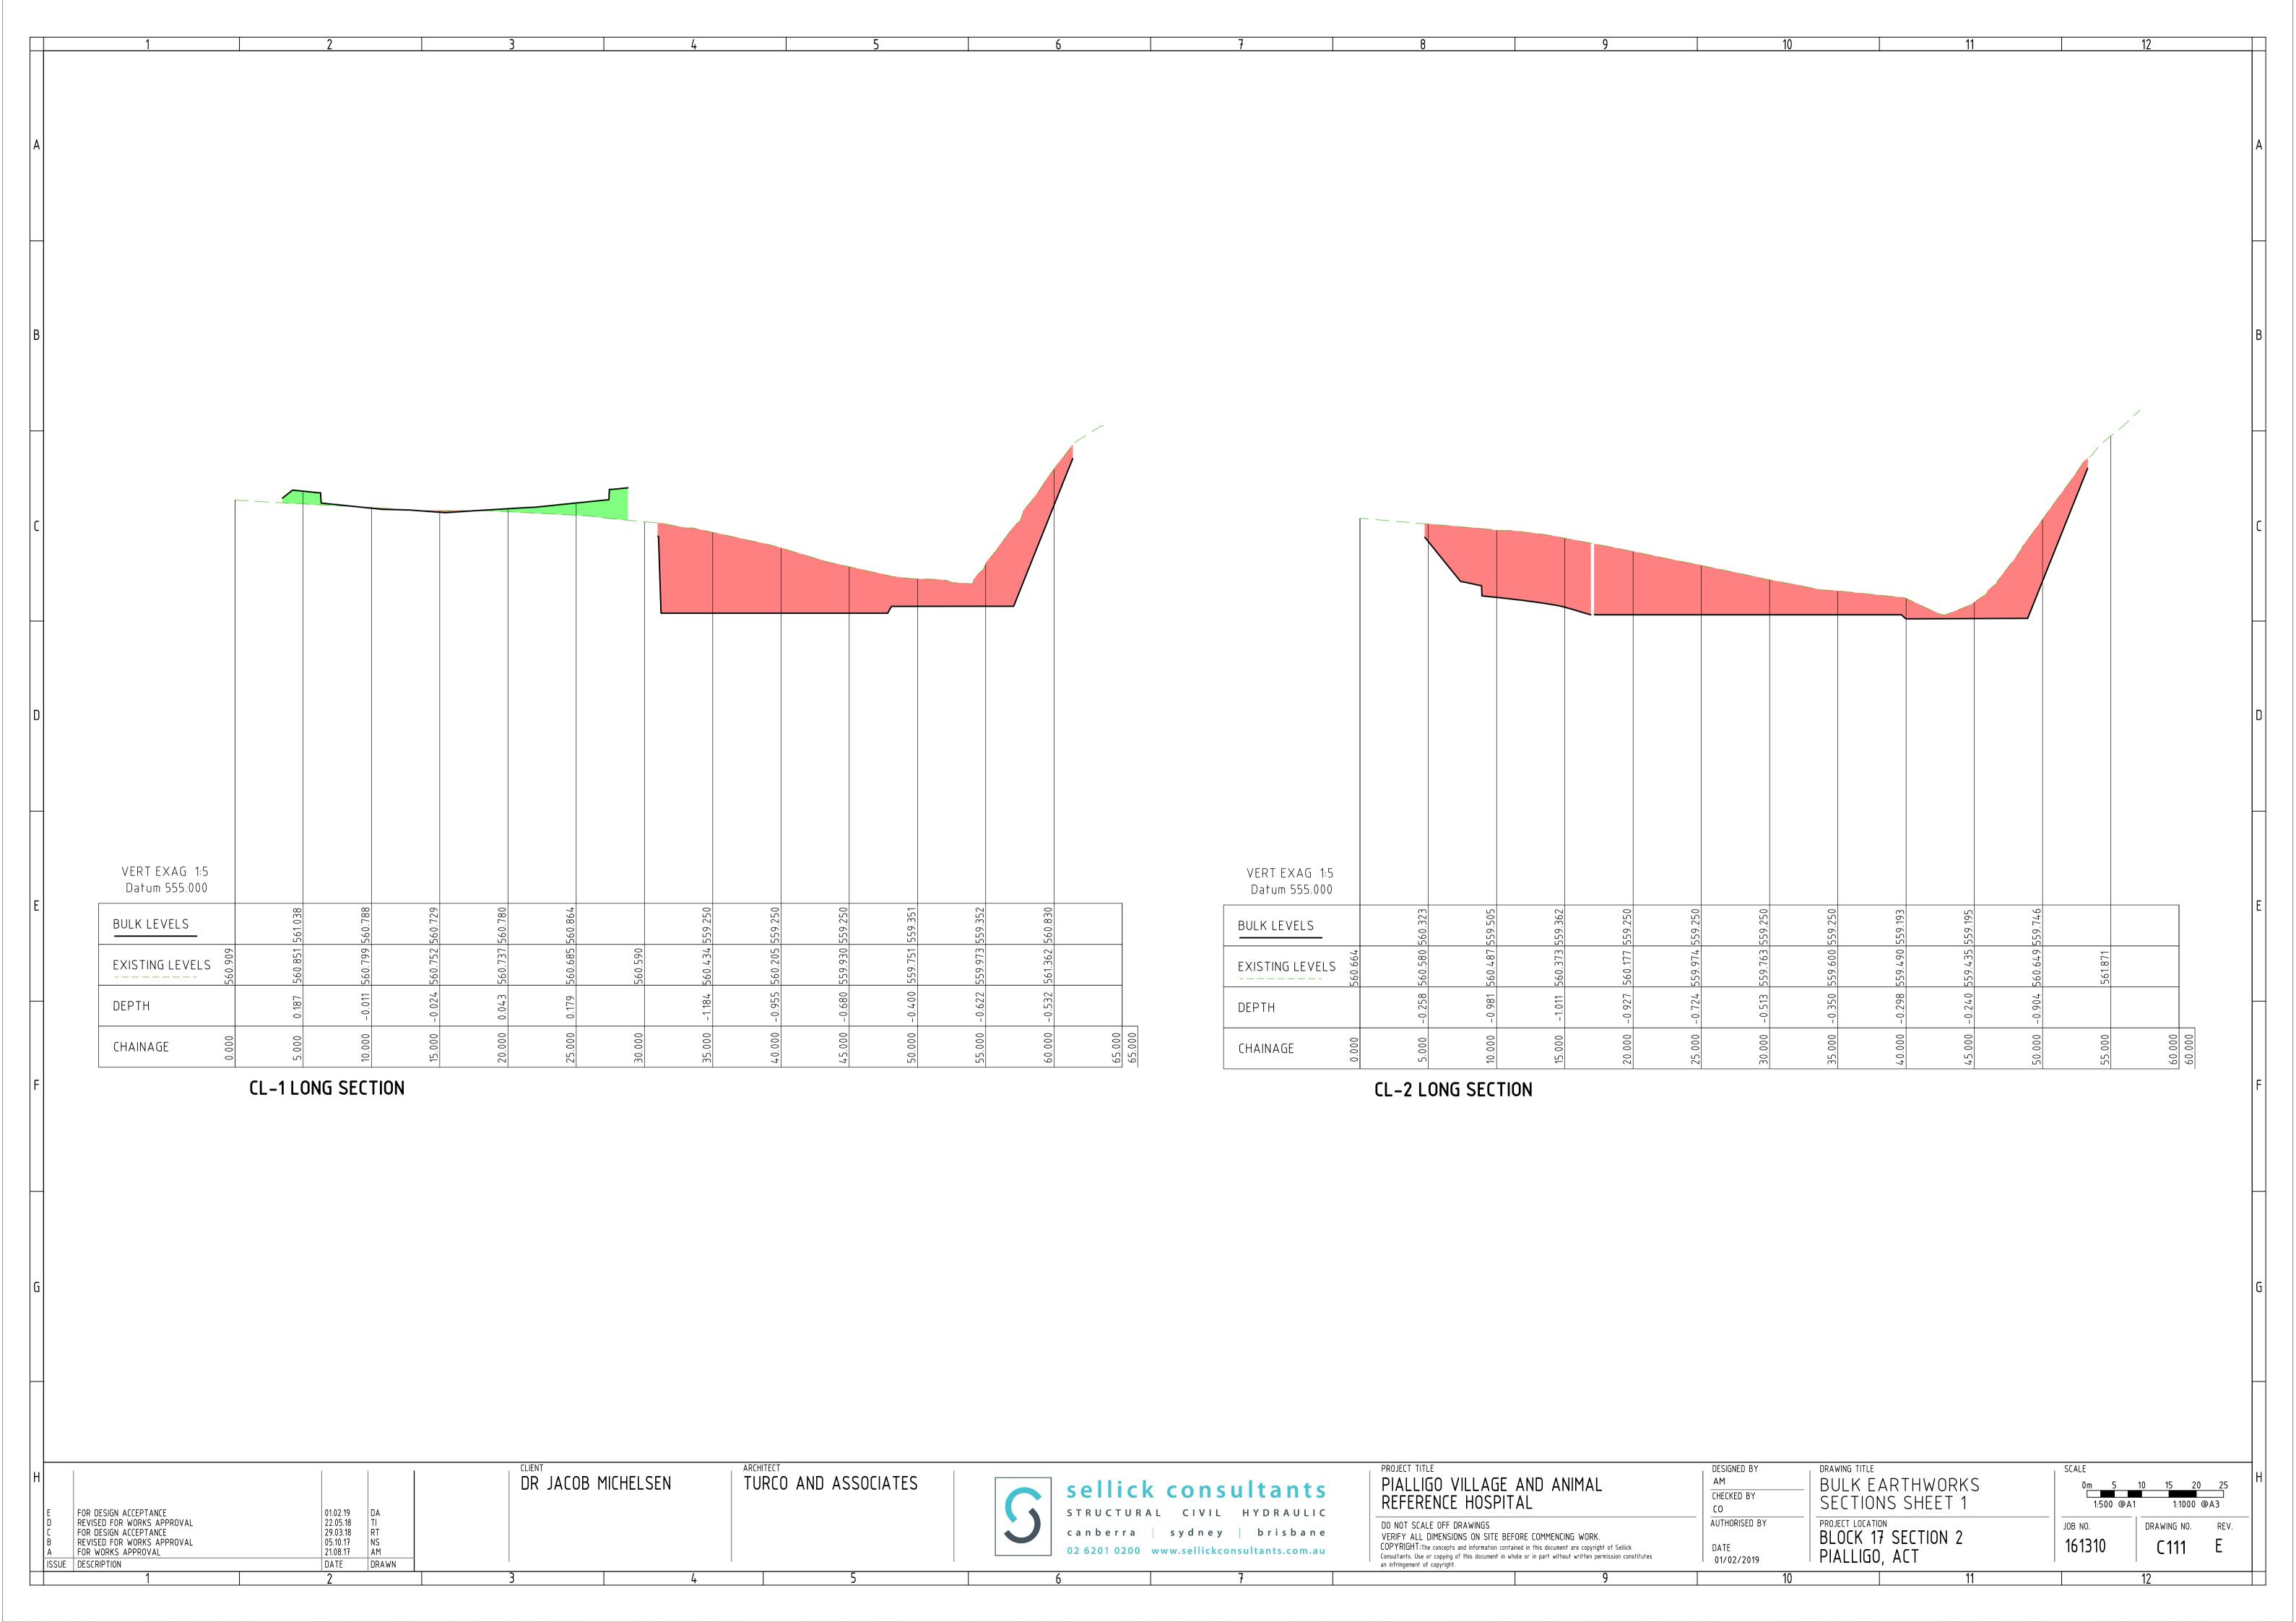

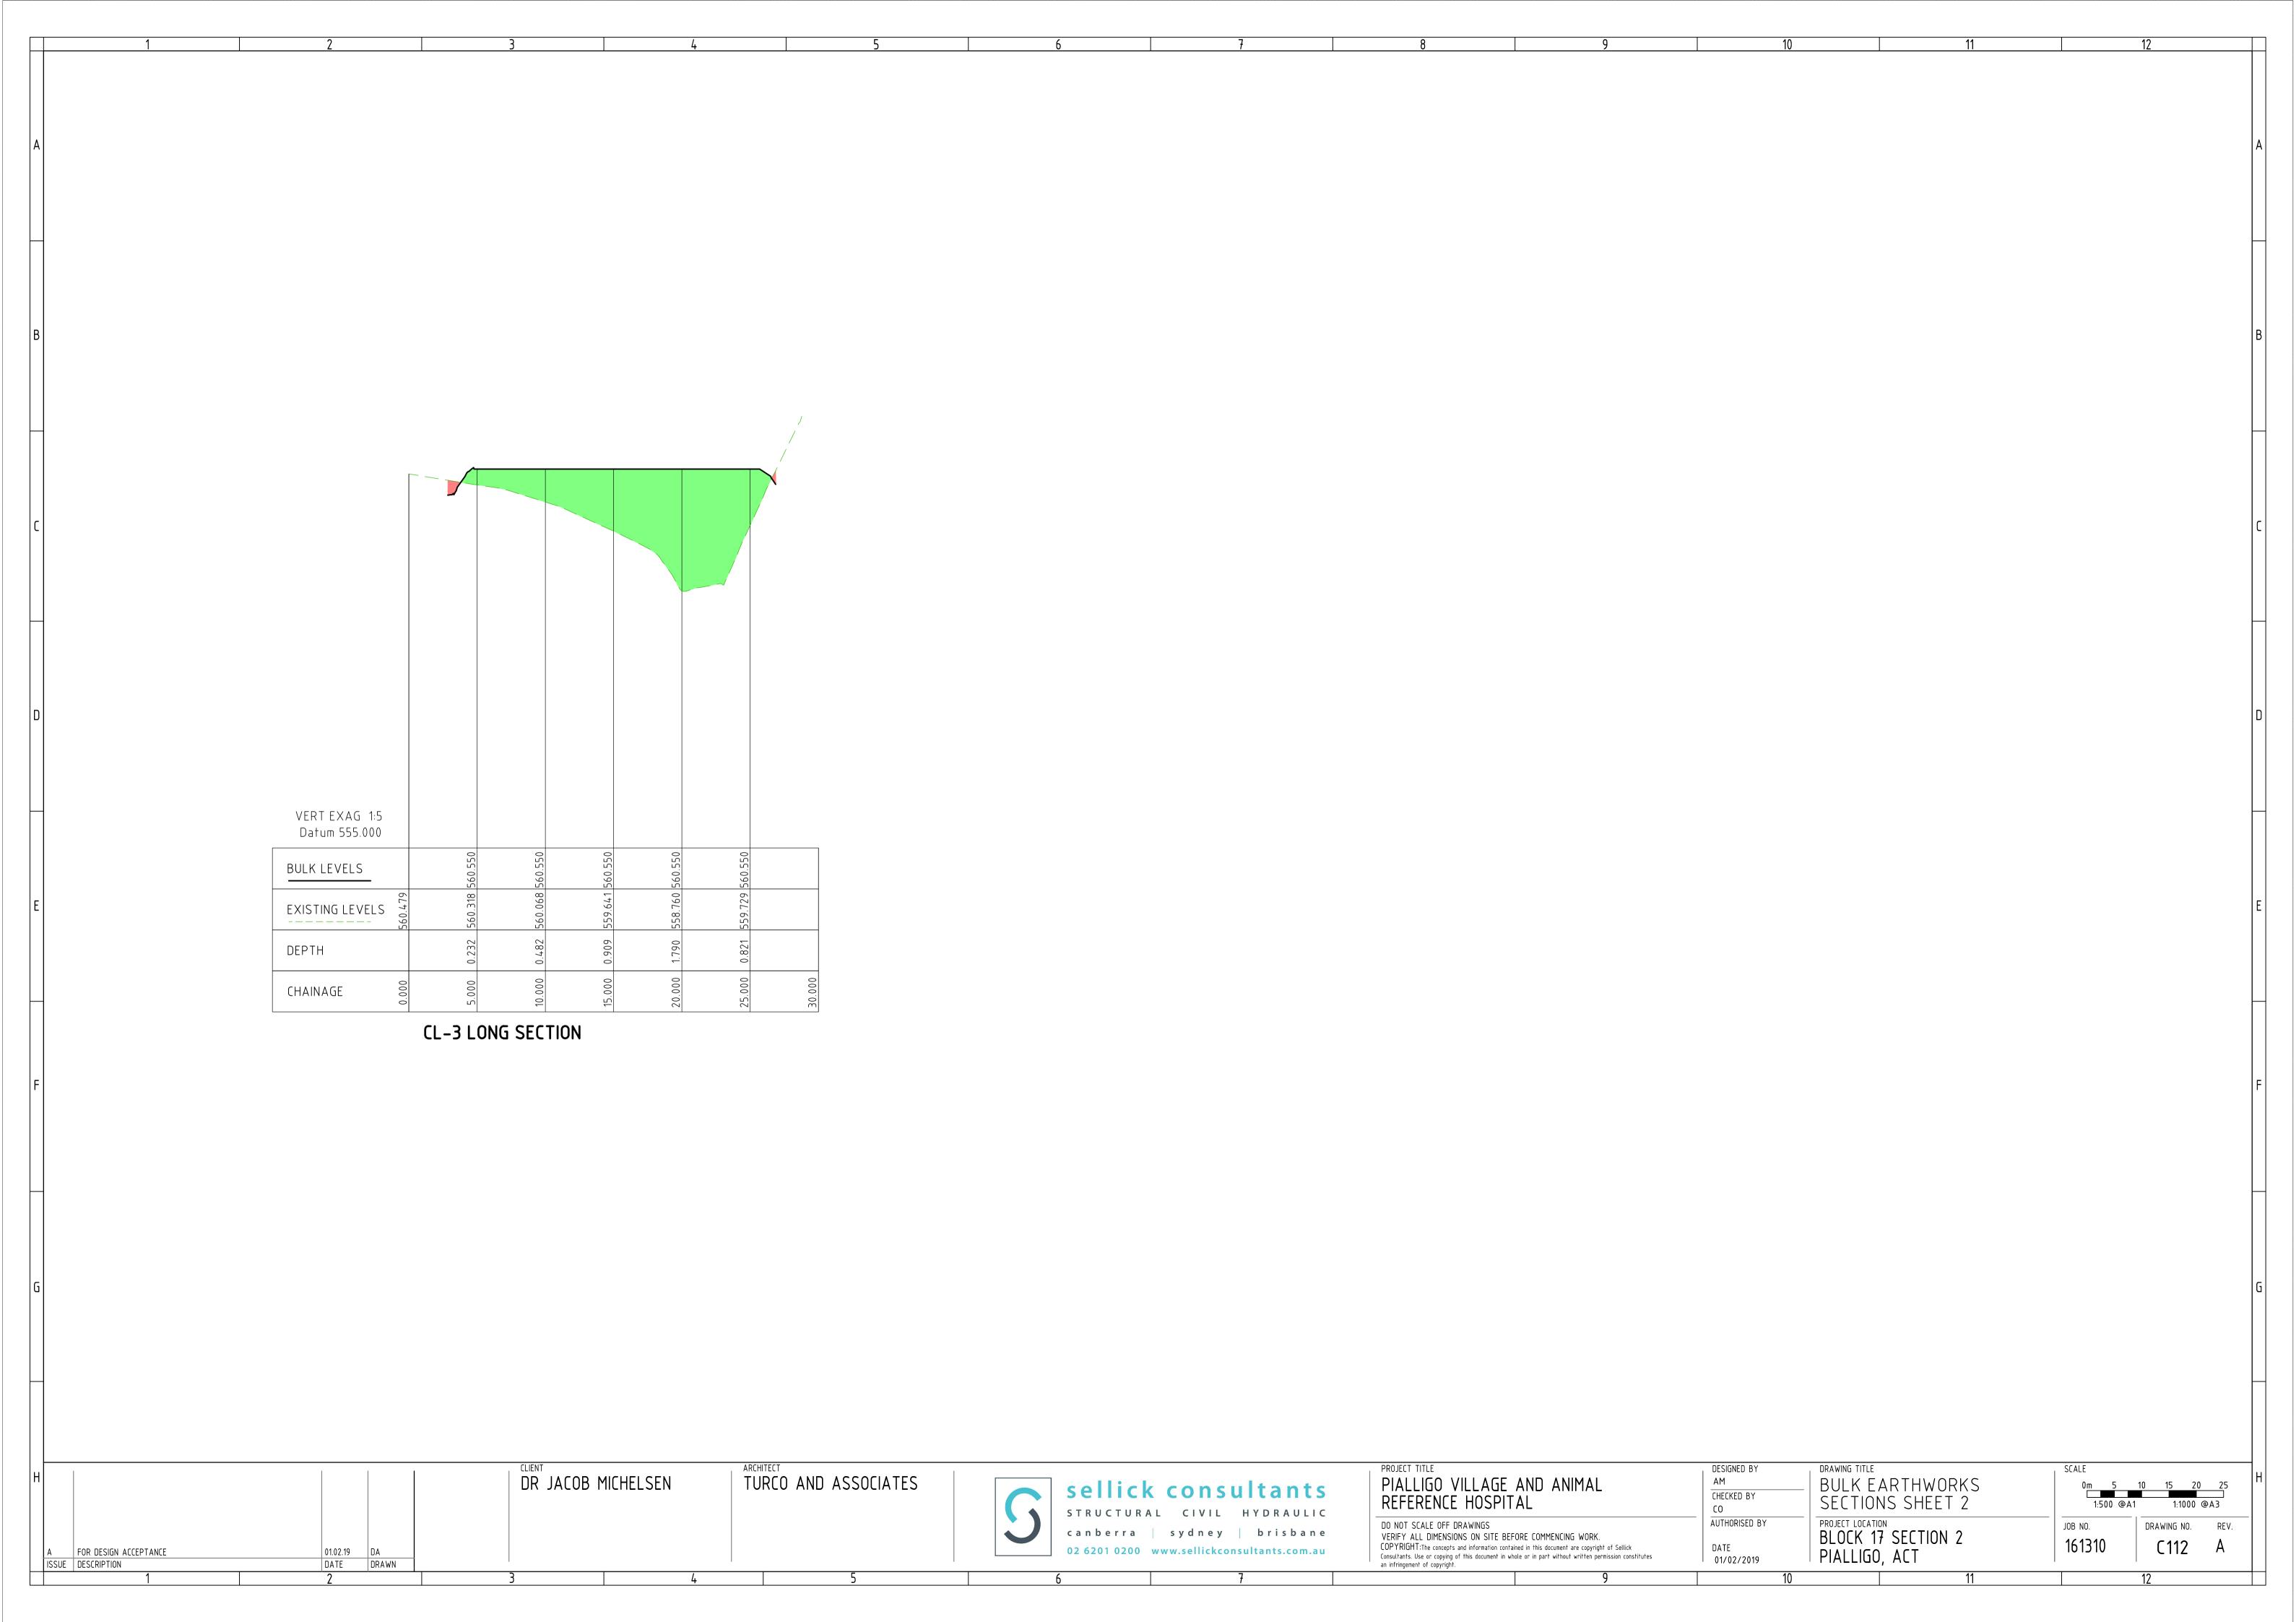


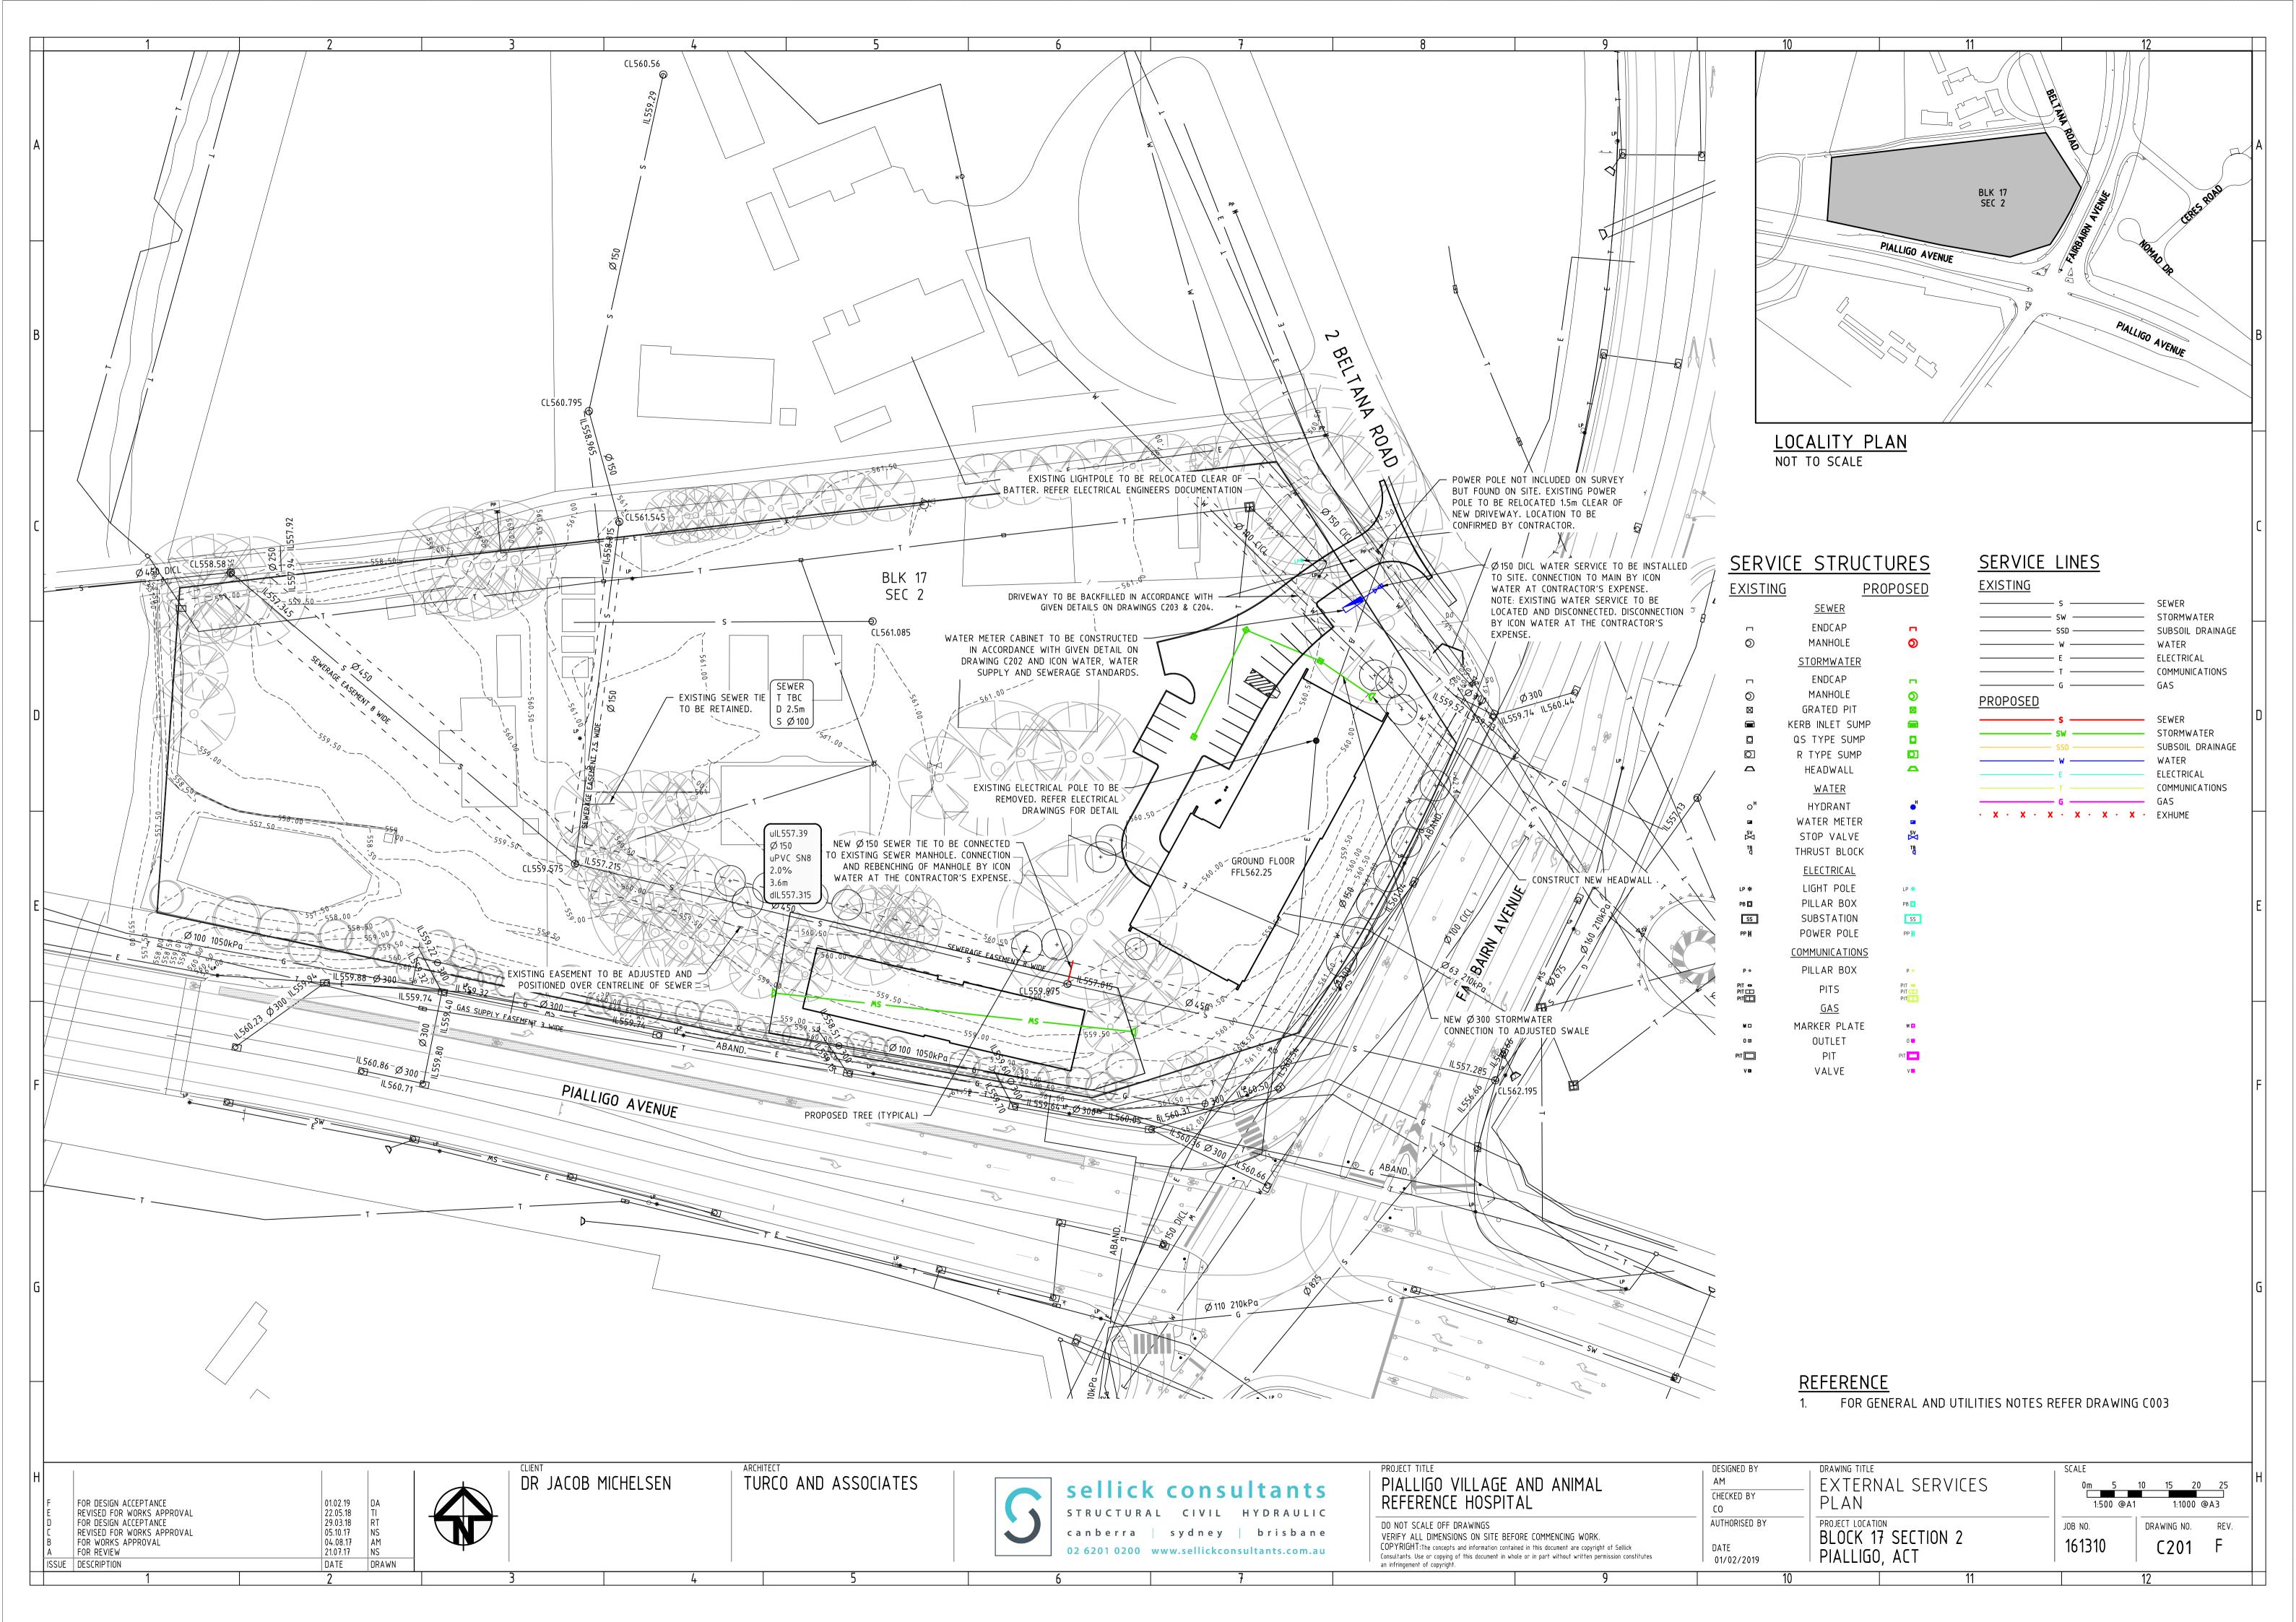

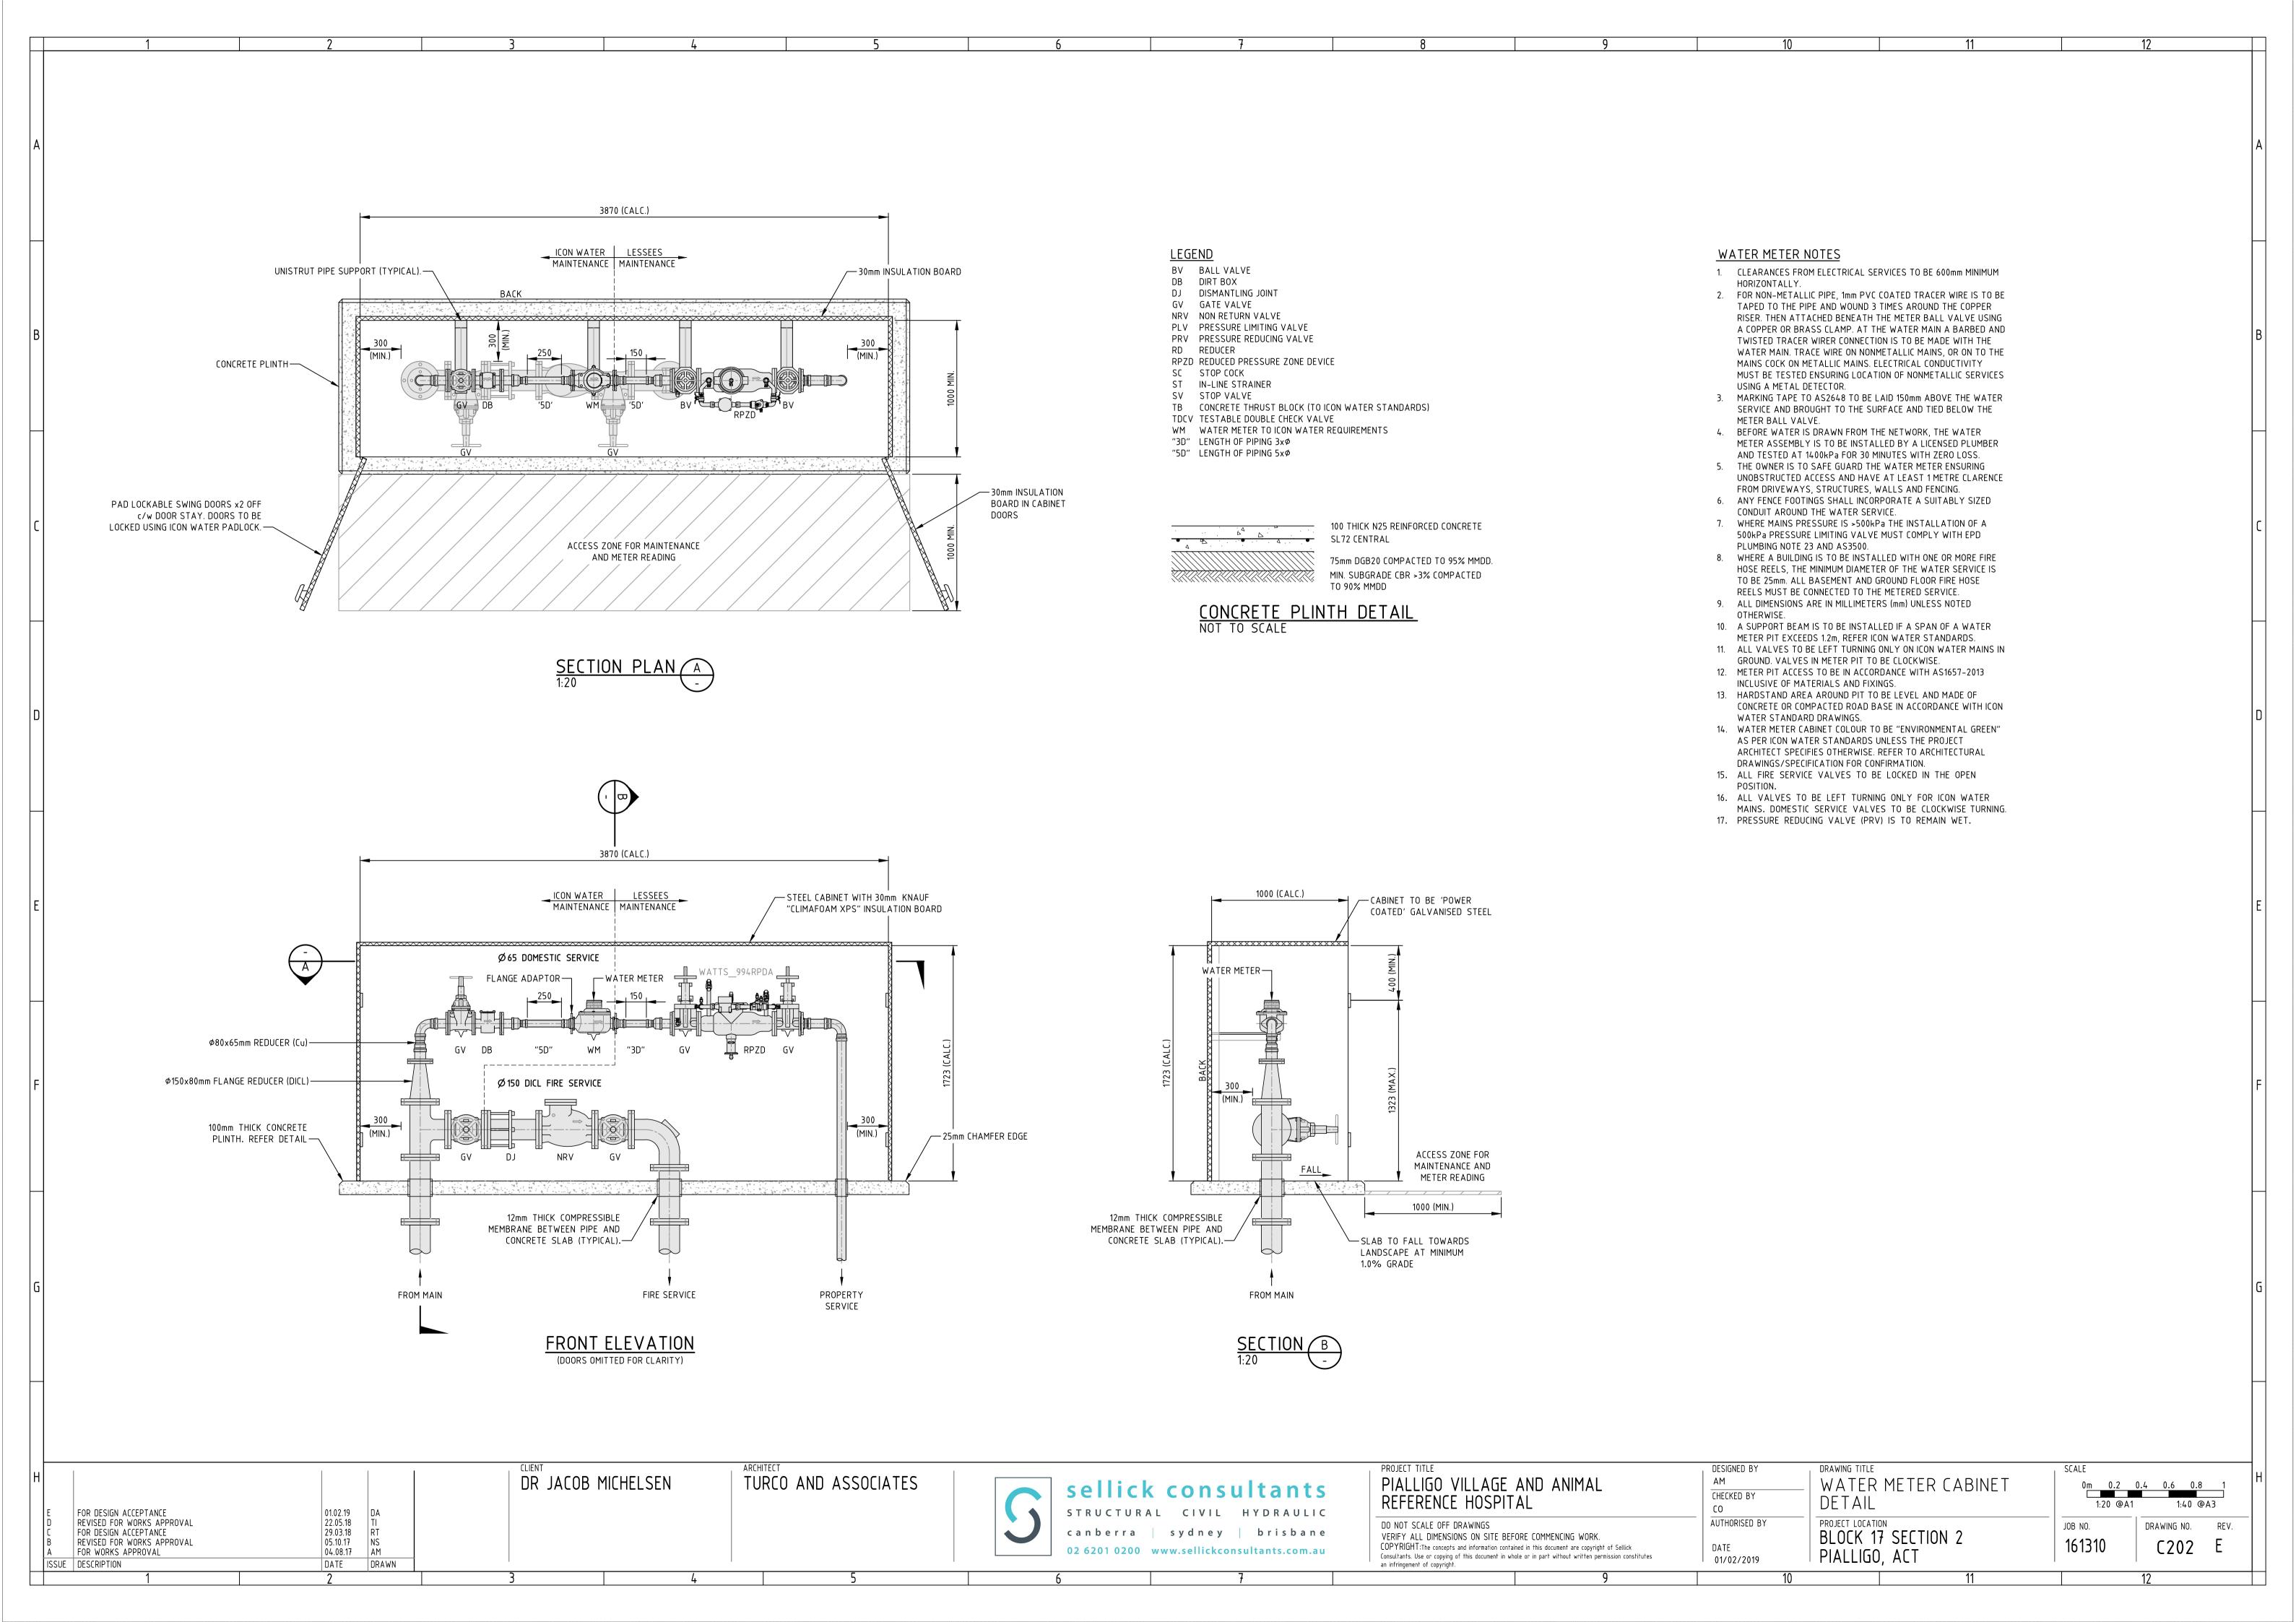

MINIMUM COMPACTION OF EMBEDMENT						
		MINIMUM VALUE (%				
MATERIAL TYPE	TECT METHOD	TRAFFICABLE AREAS		NON-TRAFFICABLE AREAS		
	TEST METHOD	EMBEDMENT	TRENCH/ EMBANKMENT FILL	EMBEDMENT	TRENCH/ EMBANKMENT FILL	
COHESIONLESS (c3)	DENSITY INDEX (I <sub>D</sub> ) AS1289.5.6.1	FLEXIBLE PIPES: 70 (NOTE C1) RIGID PIPE 70 (c1 AND c4)	70 (c2)	60	60	
COHESION	DRY DENSITY RATIO (R <sub>D</sub> ) TO AS 1289.5.4.1 & HILF DENSITY (c3) TO AS 1289.5.7.1	FLEX PIPES: 95 RIGID PIPES: 95	95	90	90	

- c1. SINGLE SIZE COARSE AGGREGATES
- c2 THE ROAD OWNER (e.g TCCS) MAY SPECIFY ALTERNATIVE VALUES.
- c3 GRADED GRAVELS AND SANDS HAVING FINES (SILTS AND CLAYS) GREATER THAN 5% TO HAVE THEIR COMPACTION DETERMINED BY THE DRY DENSITY RATIO TEST METHOD.
- c4 INCREASE PIPE CLASS TO AVOID USING SUPPORT TYPE BETTER THAN HS2 FOR GREATER BURIED DEPTH/ COVER.

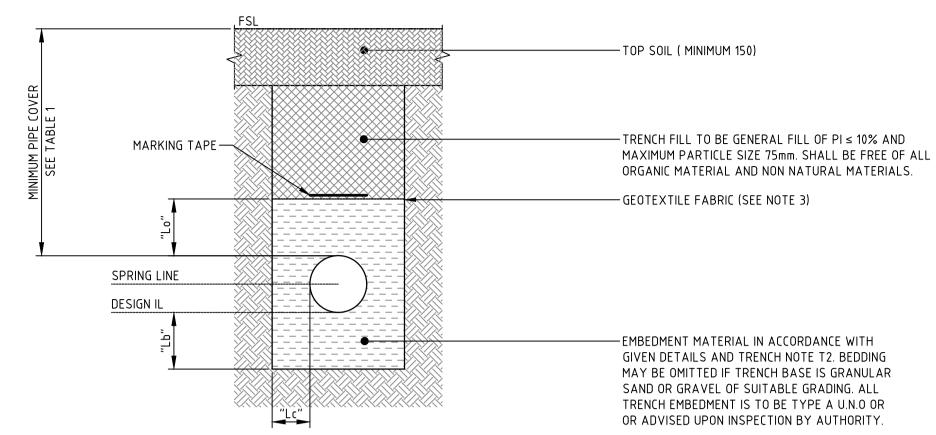


### NON TRAFFICABLE AREAS INCLUDE:

1. INCLUDE LOCATIONS WHERE OCCASIONAL VEHICLE LOADING OCCURS SUCH AS RESERVES, VERGES OUTSIDE THE TRAFFICABLE AREA.

## TRENCH NOTES

- T1. COMPACT AND EVENLY GRADE TRENCH FLOOR.
- T2. EMBEDMENT, TRENCH FILL AND COMPACTION TO MEET THE REQUIREMENTS OF DESIGN DRAWINGS AND WSA 02 2014 V3.1 FOR SEWER AND WSA 03 FOR WATER AS AMENDED BY ICON WATER SUPPLEMENTS STD-SPE-G-011 AND 012 DESPECTIVELY
- T3. USE GEOTEXTILE FILTER FABRIC WHERE SPECIFIED.
- T4. SIDES OF EXCAVATION TO BE KEPT VERTICAL TO AT LEAST 150 ABOVE PIPE.
- T5. ALL TRENCH EMBEDMENT IS TO BE TYPE A U.N.O OR ADVISED UPON INSPECTION BY AUTHORITY.

# TRENCH DETAILS / NON TRAFFICABLE AREAS BENEATH RESERVES AND VERGES SCALE 1:10

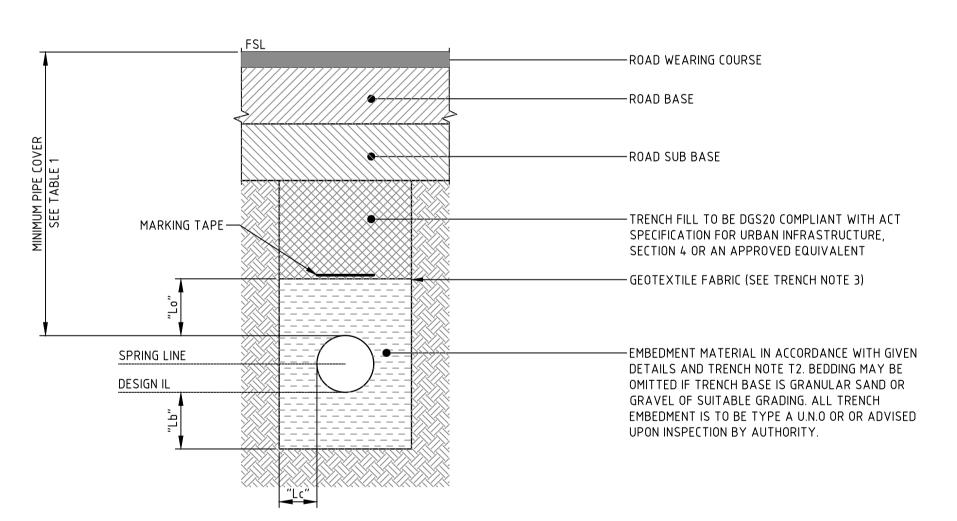

## TRAFFICABLE AREAS INCLUDE:

- THE FULL WIDTH OF ANY EXISTING OR PROPOSED ROAD CARRIAGEWAY PLUS SHOULDERS AND EXTENDING TO 1.0m BEYOND THE SHOULDERS AND KERBS.
- 2. THE FULL WIDTH OF ANY PROPERTY ACCESS DRIVEWAYS AND
- EXTENDING 1.0m EITHER SIDE.

  3. THE FULL LENGTH OF ANY CONSTRUCTION FOOTPATH INCLUDING, BUT NOT LIMITED TO, CONCRETE, ASPHALT AND CRUSHED ROCK
- PAVEMENTS.

  4. THE FULL WIDTH OF ANY MEDIAN STRIP.

  5. ANY OTHER AREA SUBJECT TO VEHICULAR TRAFFIC.
- T1 CON

TRENCH NOTES

- T1. COMPACT AND EVENLY GRADE TRENCH FLOOR.
- T2. EMBEDMENT, TRENCH FILL AND COMPACTION TO MEET THE REQUIREMENTS OF DESIGN DRAWINGS AND WSA 02 2014 V3.1 FOR SEWER AND WSA 03 FOR WATER AS AMENDED BY ICON WATER SUPPLEMENTS STD-SPE-G-011 AND 012 RESPECTIVELY.
- T3. USE GEOTEXTILE FILTER FABRIC WHERE SPECIFIED.
- T4. SIDES OF EXCAVATION TO BE KEPT VERTICAL TO AT LEAST 150 ABOVE PIPE.
- T5. ALL TRENCH EMBEDMENT IS TO BE TYPE A U.N.O OR ADVISED UPON INSPECTION BY AUTHORITY.

TRENCH DETAILS / TRAFFICABLE AREAS
BENEATH ROADS, DRIVEWAYS AND PATHS
SCALE 1:10

TABLE 1: MINIMUM PIPE COVER					
LOCATION	GRAVITY SEWER	WATER			
PUBLIC AND PRIVATE BLOCKS, NOT SUBJECT TO VEHICULAR LOADING.	600 - NEW DEVELOPMENTS 450 - EXISTING DEVELOPMENT	450#			
PRIVATE BLOCKS ZONED RESIDENTIAL, SUBJECT TO VEHICULAR LOADING.	750	450#			
FOOTPATHS, NATURE STRIPS, INDUSTRIAL AND COMMERCIAL BLOCKS, SEALED ROADS PAVEMENTS OTHER THAN MAJOR ROADS SUBJECT TO VEHICULAR LOADING.	900	600			
UNSEALED AND MAJOR ROADS.	1200	750			
FUTURE ROAD, RAIL AND TRAM PAVEMENTS.	1200	1200			

WHERE MINIMUM COVER CANNOT BE ACHIEVED, ALTERNATIVE PROTECTION TO PIPE LINES WILL BE PROVIDED.

# LESSER COVER PERMISSIBLE IN AS 3500 NOT TAKEN INTO ACCOUNT AND SHALL BE ASSESSED AS PER AS 3500 AND SOUND ENGINEERING PRINCIPLES.

TABLE 2 : TRENCH CLEARANCE					
TABLE 2	· INCINCII CEL	ANANCE			
NOMINAL PIPE DIAMETER (DN)	CLEARANCE AT SPRING LINE ("Lc")	BED ZONE UNDER PIPE ("Lb")	DEPTH OF OVERLAY ("Lo")		
≤ 150	100	100-150	150		
>150 - ≤ 300	150	100-200	150		
>300 - ≤ 450	200	100-200	150		
>450 - ≤ 900	300	100-200	150		


- 1. TRENCH WIDTH SHALL BE SUFFICIENT TO SAFELY LAY PIPE AND COMPACT TRENCH MATERIAL.
- 2. ENSURE BEDDING IS DEEP ENOUGH THAT PIPE JOINTS (SOCKETS AND FLANGES) DO NOT TOUCH THE TRENCH
- FLOOR.

  3. TABLE BASED ON FLEXIBLE PIPELINE INSTALLATION ONLY. NOT CONCRETE, DICL OR VC

TABLE 3 : CLEARANCES	BETWEEN SEV UTILITIES	WER AND UND	ERGROUND
OTHER UTILITIES		IIMUM HORIZONTAL CLEARANCE (mm) NEW SEWER SIZE	
	≤ DN 300	>DN 300	CLEARANCE (mm)
SEWER ≤ DN 300	300	600	150/300
SEWER >DN 300	600	600	300
GAS	300	600	150/300
TELECOMMUNICATIONS	300	600	150/300
ELECTRICITY	500	1000	225/300
STORMWATER	300	600	150
WATER	1000/600	1000/600	500

REFER TO CLAUSE 5.4.5.2 OF WSA 02 FOR NOTES SPECIFICALLY RELATED TO THIS TABLE

A FOR DESIGN ACCEPTANCE   01.02.19   DA     Casultants.com.au   Consultants.com.au   Consultants.line conjuging of this document in whole or in part without written permission constitutes   DATE   D	H	FOR DESIGN ACCEPTANCE 01.02.19 DA	DR JACOB MICHELSEN	TURCO AND ASSOCIATES	Sellick consultants  STRUCTURAL CIVIL HYDRAULIC  canberra   sydney   brisbane  02 6201 0200 www.sellickconsultants.com.au	PROJECT TITLE  PIALLIGO VILLAGE AND ANIMAL  REFERENCE HOSPITAL  DO NOT SCALE OFF DRAWINGS  VERIFY ALL DIMENSIONS ON SITE BEFORE COMMENCING WORK.  COPYRIGHT: The concents and information contained in this document are convicint of Sellick	DESIGNED BY  AM  CHECKED BY  CO  AUTHORISED BY  DATE	DRAWING TITLE  TRENCH BACKFILL DETAILS SHEET 1  PROJECT LOCATION BLOCK 17 SECTION 2	SCALE NOT TO SCALE  JOB NO. DRAWING NO. C203	H REV.
--	---	-----------------------------------	--------------------	----------------------	---	---	--	---	--	--------

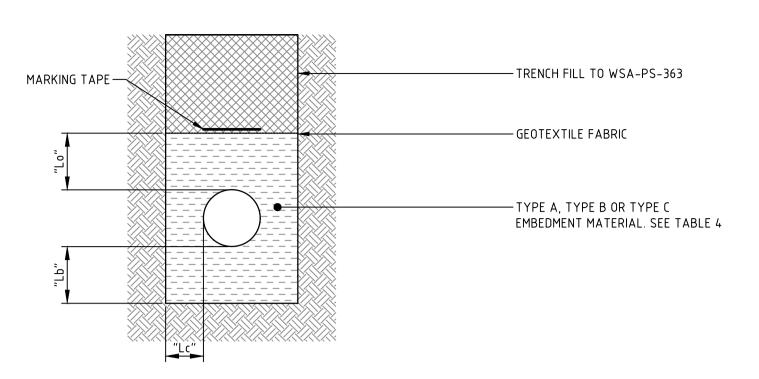

TRENCH EMBEDMENTS

TYPES A, B AND C MATERIAL

SCALE 1:10

	TABLE 4					
EMBEDMENT TYPE	APPLICATION	APPROVED MATERIALS				
TYPE A - STANDARD	FOR USE WHERE THERE ARE NO STRUCTURAL ISSUES OR GROUND WATER.	WSA PS 350, WSA PS 360, WSA PS361.				
TYPE B-CEMENT STABILISED SAND	FOR USED WHEN ASSET PROTECTION IS REQUIRED. (e.g. WATER MAINS BENEATH MAJOR CROSSINGS) OR WHEN MINIMUM COVER CAN NOT BE ACHIEVED.	WSA PS-350 (SAND) PLANT MIXED WITH 5% CEMENT PLACED AND COMPACTED DRY.				
TYPE C-CLSM	FOR USE WHERE COMPACTION IN TRENCH IS DIFFICULT TO ACHIEVE DUE TO TIME OR SPACE CONSTRAINTS OR WHERE NATIVE SOIL CONDITIONS PROVIDE INSUFFICIENT FOUNDATION STRENGTH OR SOIL MODULUS FOR SIDE SUPPORT.	WSA PS 352, 28 DAY COMPRESSIVE STRENGTH 0.7 MPa, SLUMP 180mm COMPACTION IS NOT REQUIRED.				

- 1. IF SIGNIFICANT GROUNDWATER IS OBSERVED DURING EXCAVATION BUT EMBEDMENT TYPE A IS NOMINATED IN THE DESIGN, THE DESIGNER SHALL BE CONSULTED TO RECONSIDER THE EMBEDMENT MATERIAL SELECTION AND PROVISION OF DRAINAGE.
- 2. WHEN USING CLSM, MEASURES SHALL BE TAKEN TO PREVENT

FLOATATION OF PIPE DURING PLACEMENT.

MARKING TAPE		TRENCH FILL TO WSA-PS-363
		GEOTEXTILE FABRIC
,, o,		GEOTEXTILE FABRIC
<u> </u>		EMBEDMENT MATERIAL TABLE 6
"[P		TRENCH DRAIN, 65mm CLASS 1000 SUBSOIL DRAIN (TYPICAL) 100 BALLAST (IF REQUIRED FOR
1	"Lc"	IMPROVED TRENCH FOUNDATION).

TRENCH EMBEDMENT

TYPES D - SINGLE SIZED AGGREGATE


SCALE 1:10


EMBEDMENT TYPE	APPLICATION	APPROVED MATERIALS
TYPE D - AGGREGATE (SINGLE SIZE).	FOR USE WHEN ASSET PROTECTION IS REQUIRED. (e.g. WATER MAINS BENEATH MAJOR CROSSINGS) OR WHEN MINIMUM COVER CAN NOT BE ACHIEVED.	WSA PS-350 (SAND) PLANT MIXED WITH 5% CEMENT PLACED AND COMPACTED DRY.

- EMBEDMENT SHALL BE WRAPPED IN GEOTEXTILE TO WSA PS 355, WITH MINIMUM 250 LAP AT ALL JOINTS.
- 2. IF THE TRENCH HAS SOLID ROCK ON BOTH SIDES AND BENEATH THE EMBEDMENT MATERIAL, FILTER FABRIC IS ONLY REQUIRED ON THE TOP SURFACE (AS SHOWN).
- WHERE THE TRENCH FLOOR IS SOFT (i.e BOOTS SINK INTO THE FLOOR UNDER A PERSONS WEIGHT), PRESS 100 BALLAST INTO THE TRENCH FLOOR UNTIL IT CAN TAKE A PERSONS WEIGHT WITHOUT MOVEMENT.
- FLOOR UNTIL IT CAN TAKE A PERSONS WEIGHT WITHOUT MOVEMENT.

  4. PROVIDE TRENCH STOPS AND/BULK HEADS AND TRENCH DRAINAGE (IF REQUIRED) AS PER SD-2104.
- 5. AGGREGATE TO BE WELL ROUNDED WITH NO SHARPS.6. MAXIMUM PARTIAL SIZE AS PER GIVEN TABLE.

TABLE 6 - MAXIM	UM PARTICLE SIZE
NOMINAL PIPE DIAMETER (DN)	MAXIMUM PARTICLE SIZE (mm)
<100	10
100 ≤ DN ≤ 150	14
>150	20

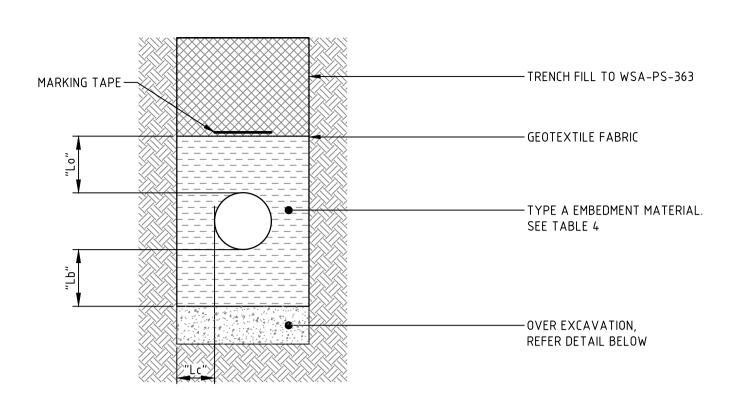

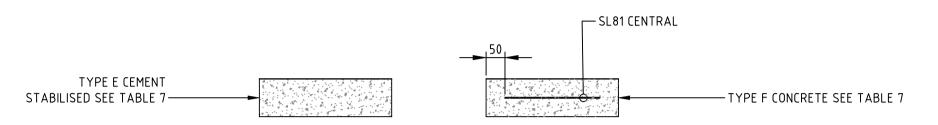



# TRENCH EMBEDMENTS TYPES E AND F MATERIAL SCALE 1:10


TABLE 7						
EMBEDMENT TYPE	APPLICATION	APPROVED MATERIALS				
TYPE E - CEMENT STABILISED SAND	FOR USE WHERE OVER EXCAVATION HAS OCCURRED DUE TO POOR SOIL CONDITIONS AND WHEN THERE IS LITTLE TO NO GROUNDWATER.	WSA PS-350 (SAND) PLANT MIXED WITH 5% CEMENT PLACED AND COMPACTED DRY.				
TYPE F - CONCRETE	FOR USE IN SHORT SPANS (<1000) OF LOW BEARING CAPACITY GROUND (SOFT CLAYS AND LOOSE SAND.	WSA PS 352, 28 DAY COMPRESSIVE STRENGTH 0.7 MPa, SLUMP 180mm COMPACTION IS NOT REQUIRED.				


- IF SIGNIFICANT GROUNDWATER IS OBSERVED DURING EXCAVATION BUT EMBEDMENT TYPE A IS NOMINATED IN THE DESIGN, THE DESIGNER SHALL BE CONSULTED TO RECONSIDER THE EMBEDMENT MATERIAL SELECTION AND PROVISION OF DRAINAGE.
- 2. CONCRETE SHALL BE SULFATE RESISTANT IF NATIVE SOIL IS CLASSIFIED AS ACID SULFATE SOIL (ASS) WHICH CONTAINS GREATER THAN 1.0% SULFATE AND NET ACID GENERATION POTENTIAL GREATER THAN 0.0.


H	DR JACOB MICHELSEN	TURCO AND ASSOCIATES	sellick consultants  STRUCTURAL CIVIL HYDRAULIC	PROJECT TITLE PIALLIGO VILLAGE AND ANIMAL REFERENCE HOSPITAL	DESIGNED BY  AM  CHECKED BY  CO	TRENCH BACKFILL DETAILS SHEET 2	SCALE 0 100 200 300 400 500mm H 1:10 @ A1
A FOR DESIGN A ISSUE DESCRIPTION			canberra   sydney   brisbane 02 6201 0200 www.sellickconsultants.com.au	DO NOT SCALE OFF DRAWINGS  VERIFY ALL DIMENSIONS ON SITE BEFORE COMMENCING WORK.  COPYRIGHT: The concepts and information contained in this document are copyright of Sellick  Consultants. Use or copying of this document in whole or in part without written permission constitutes an infringement of copyright.	DATE 01/02/2019	PROJECT LOCATION  BLOCK 17 SECTION 2  PIALLIGO, ACT	JOB NO. DRAWING NO. REV. C204 A

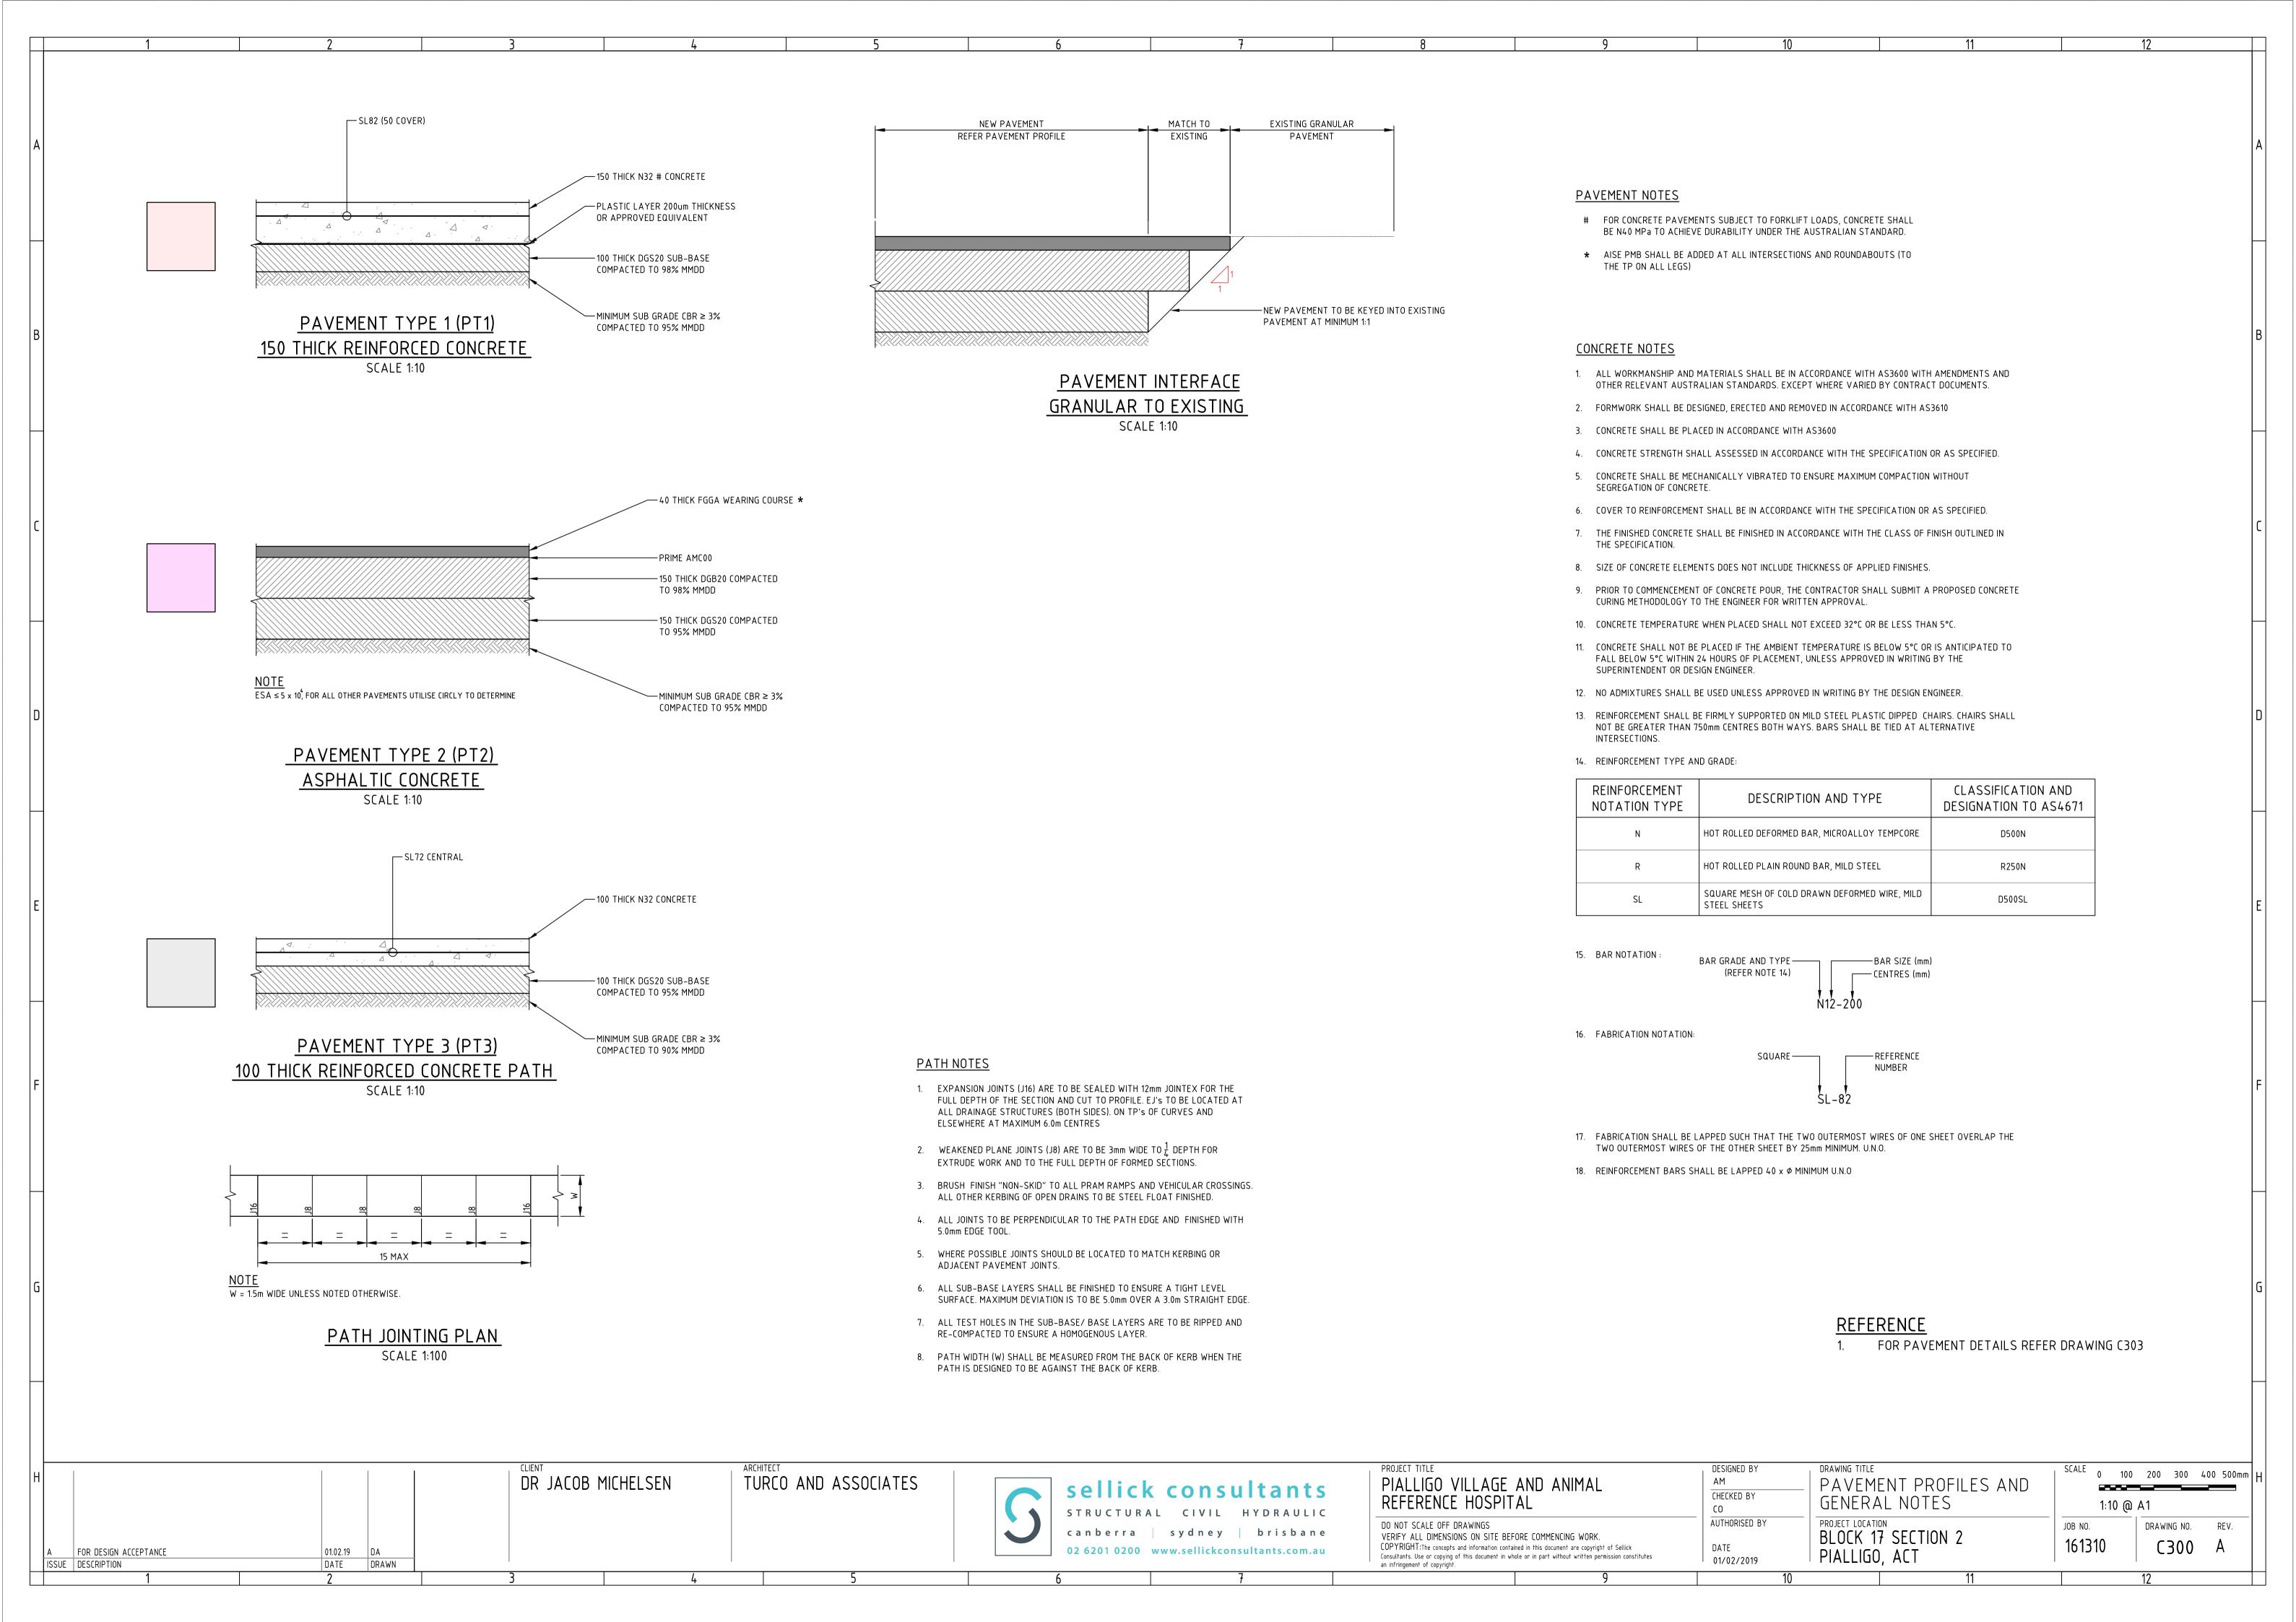


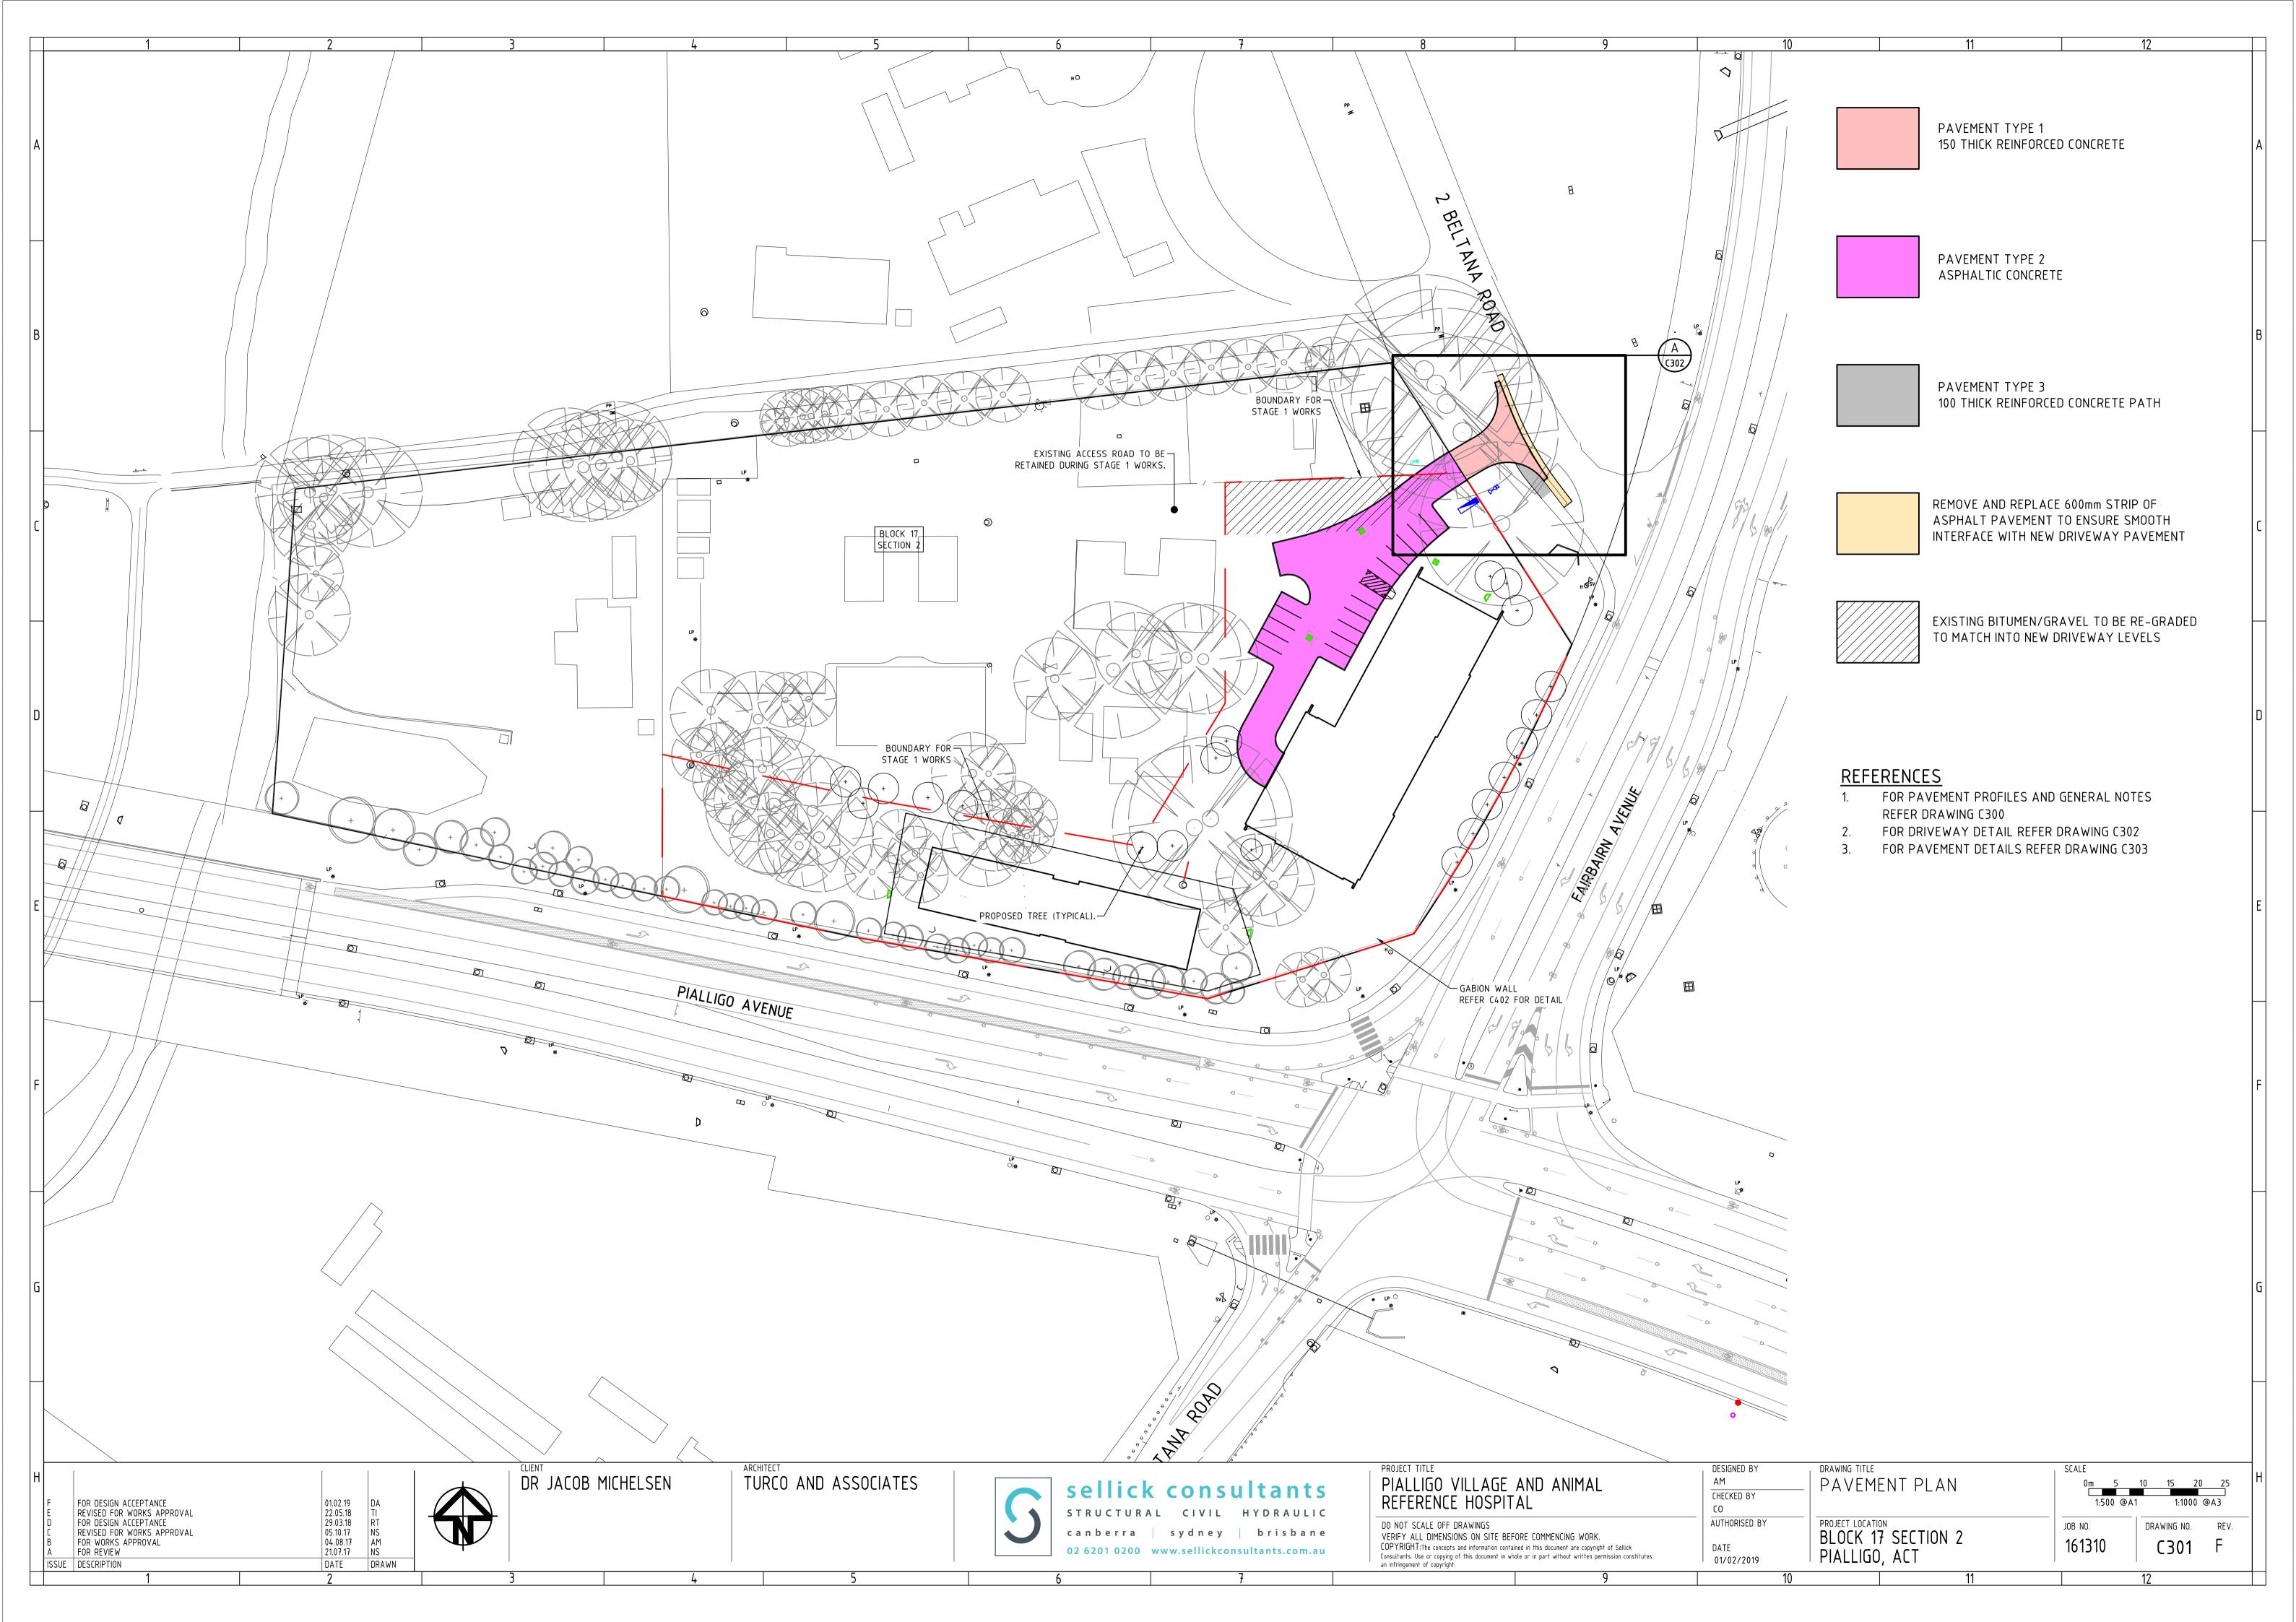


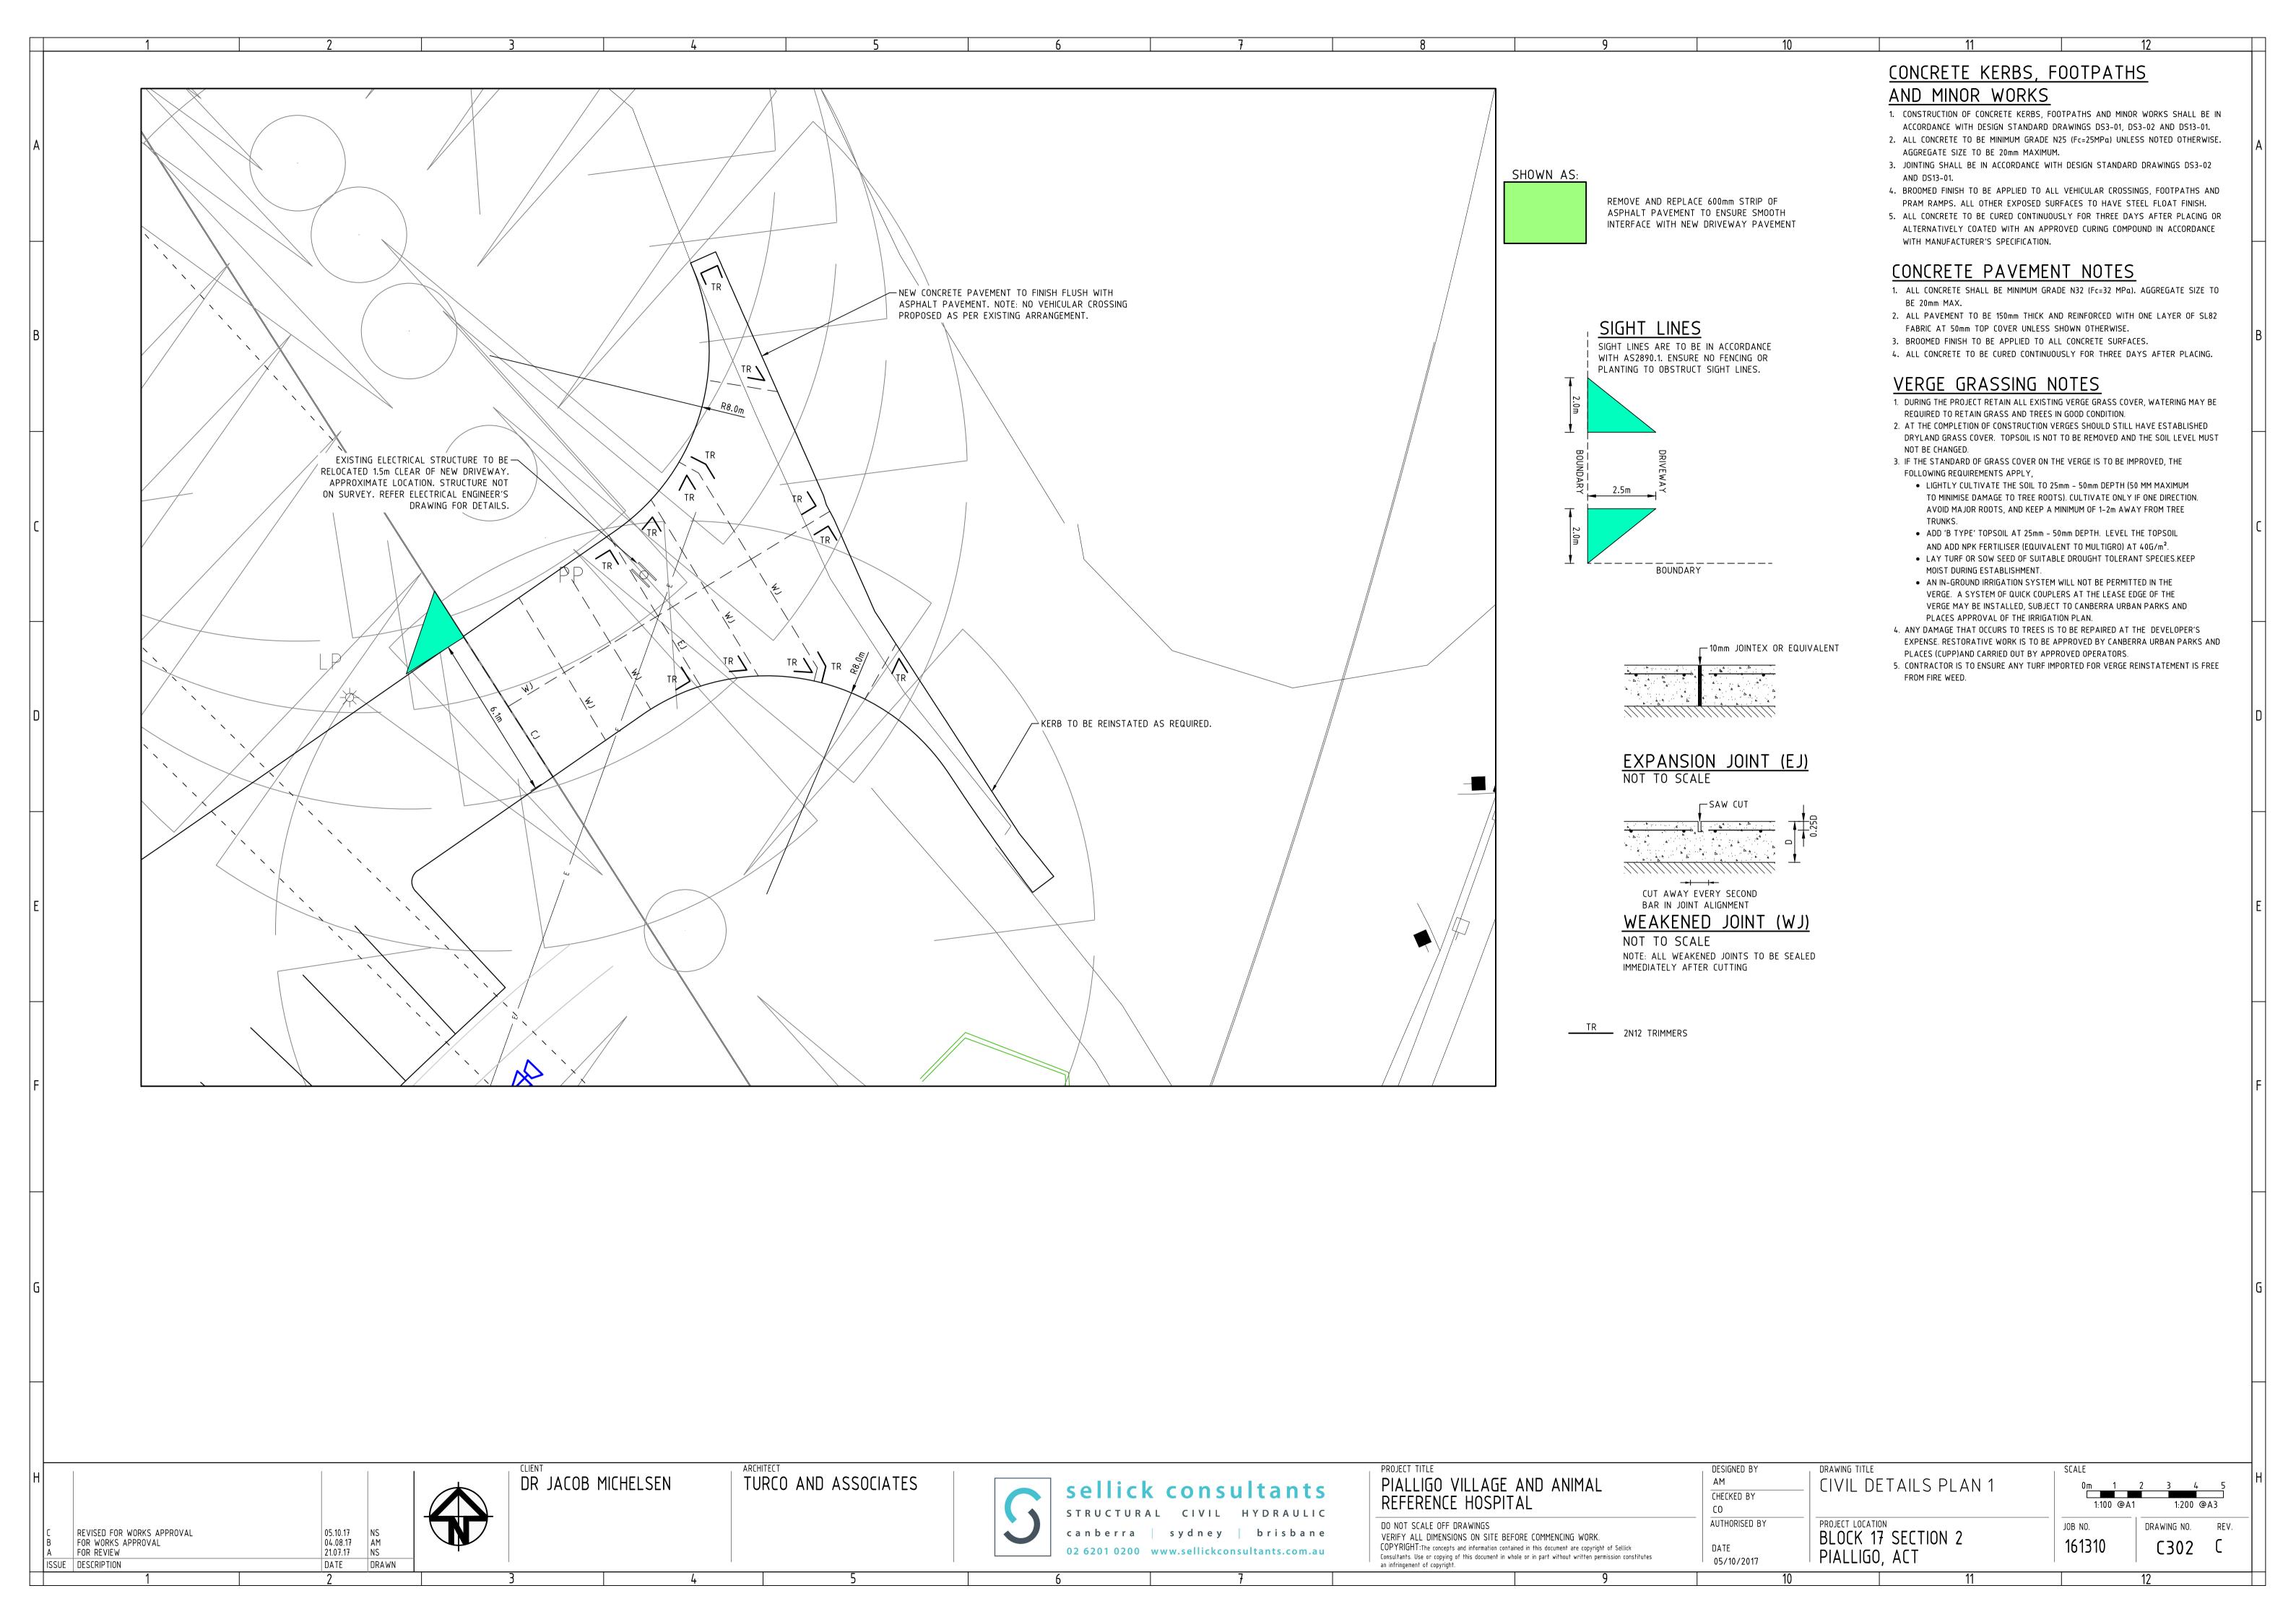

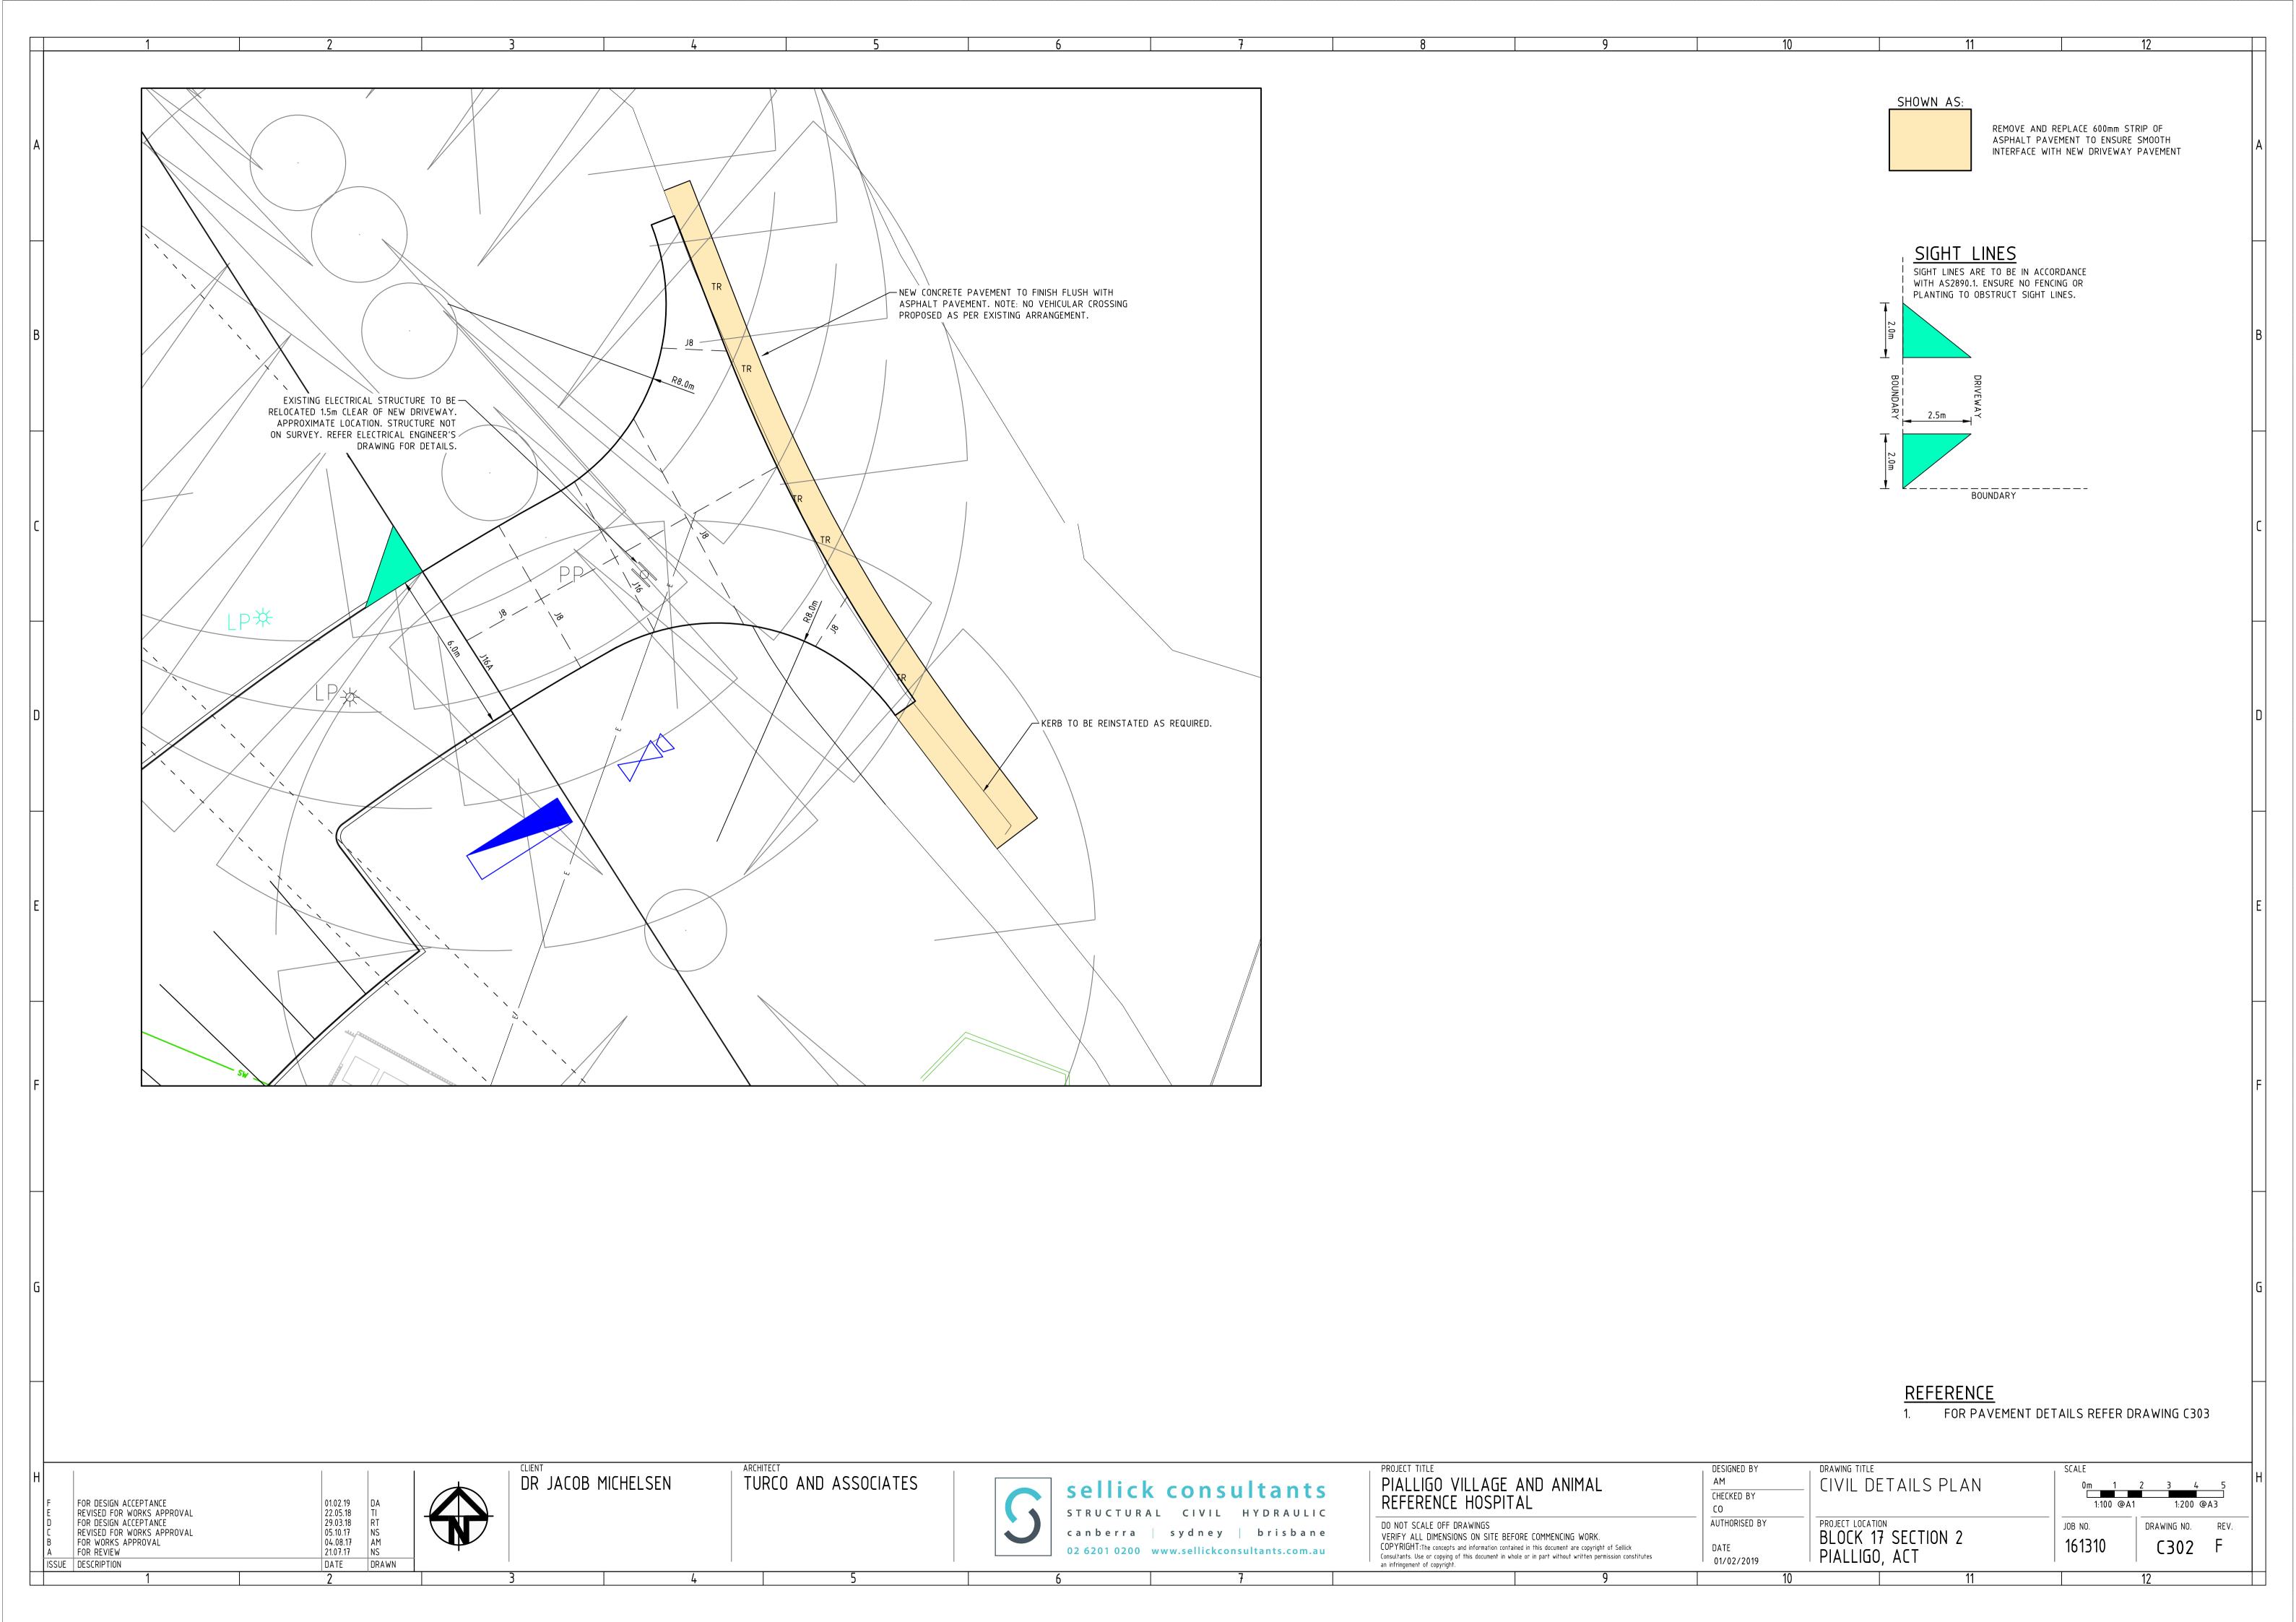


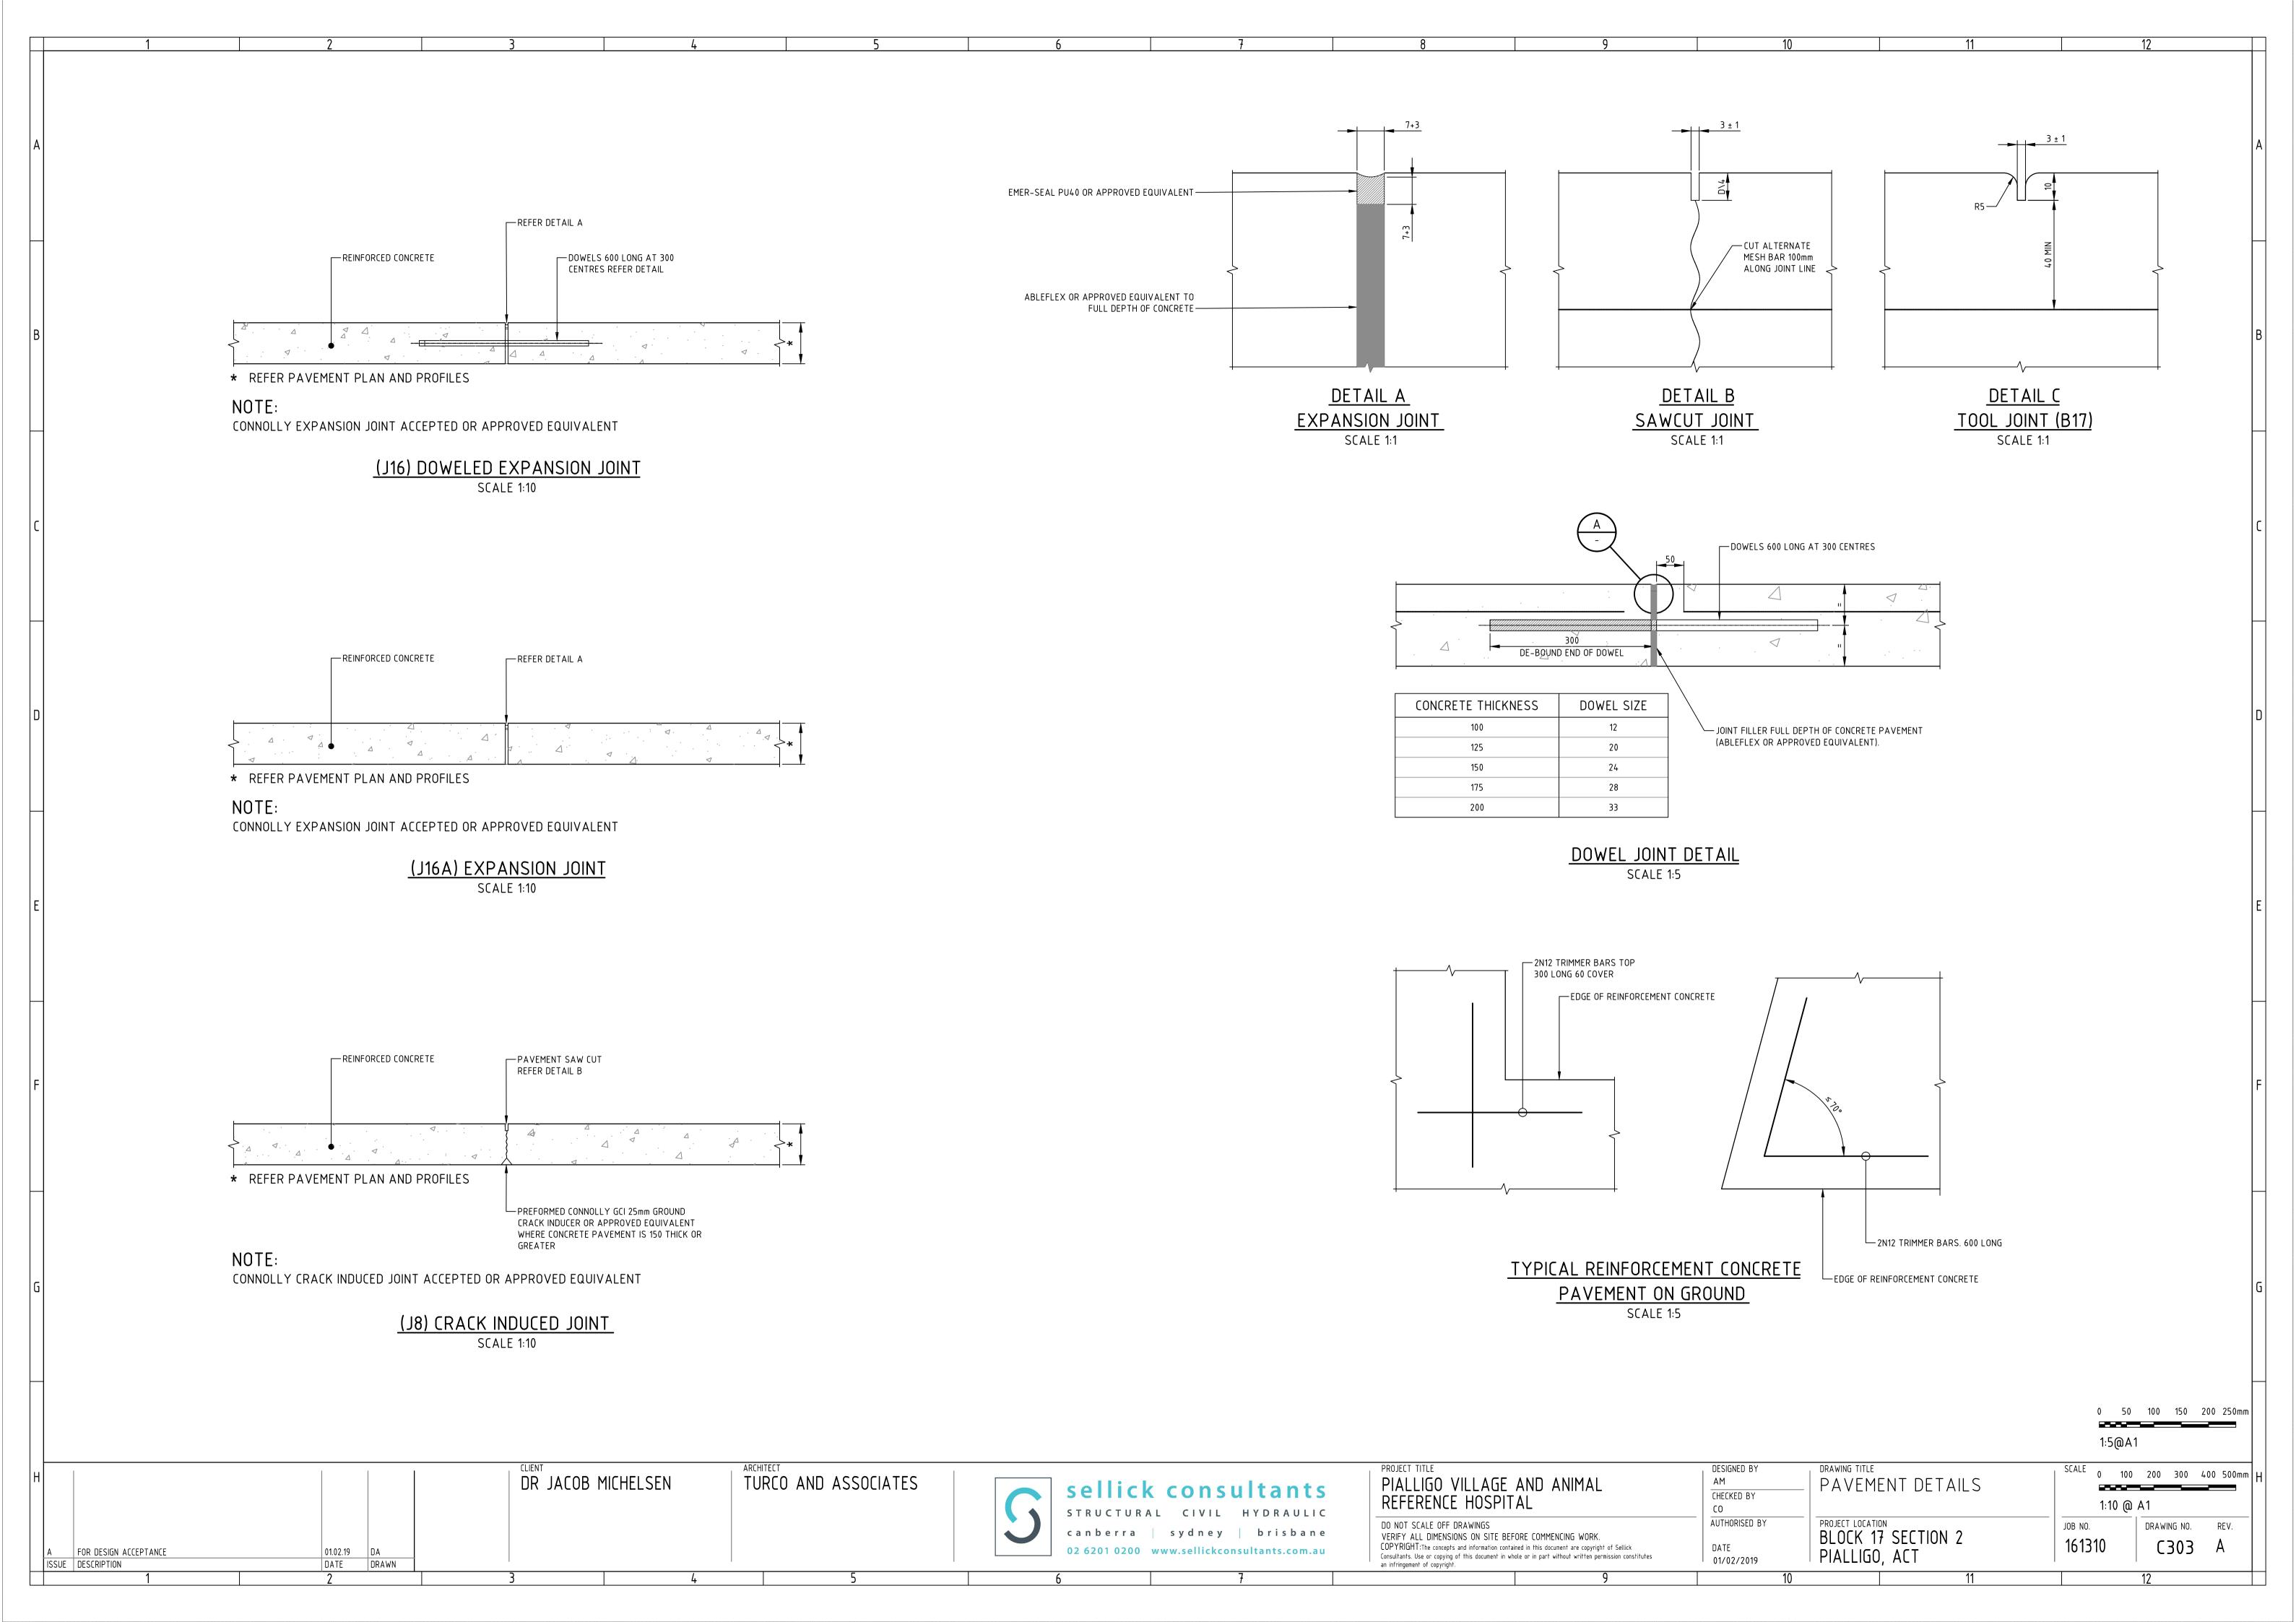

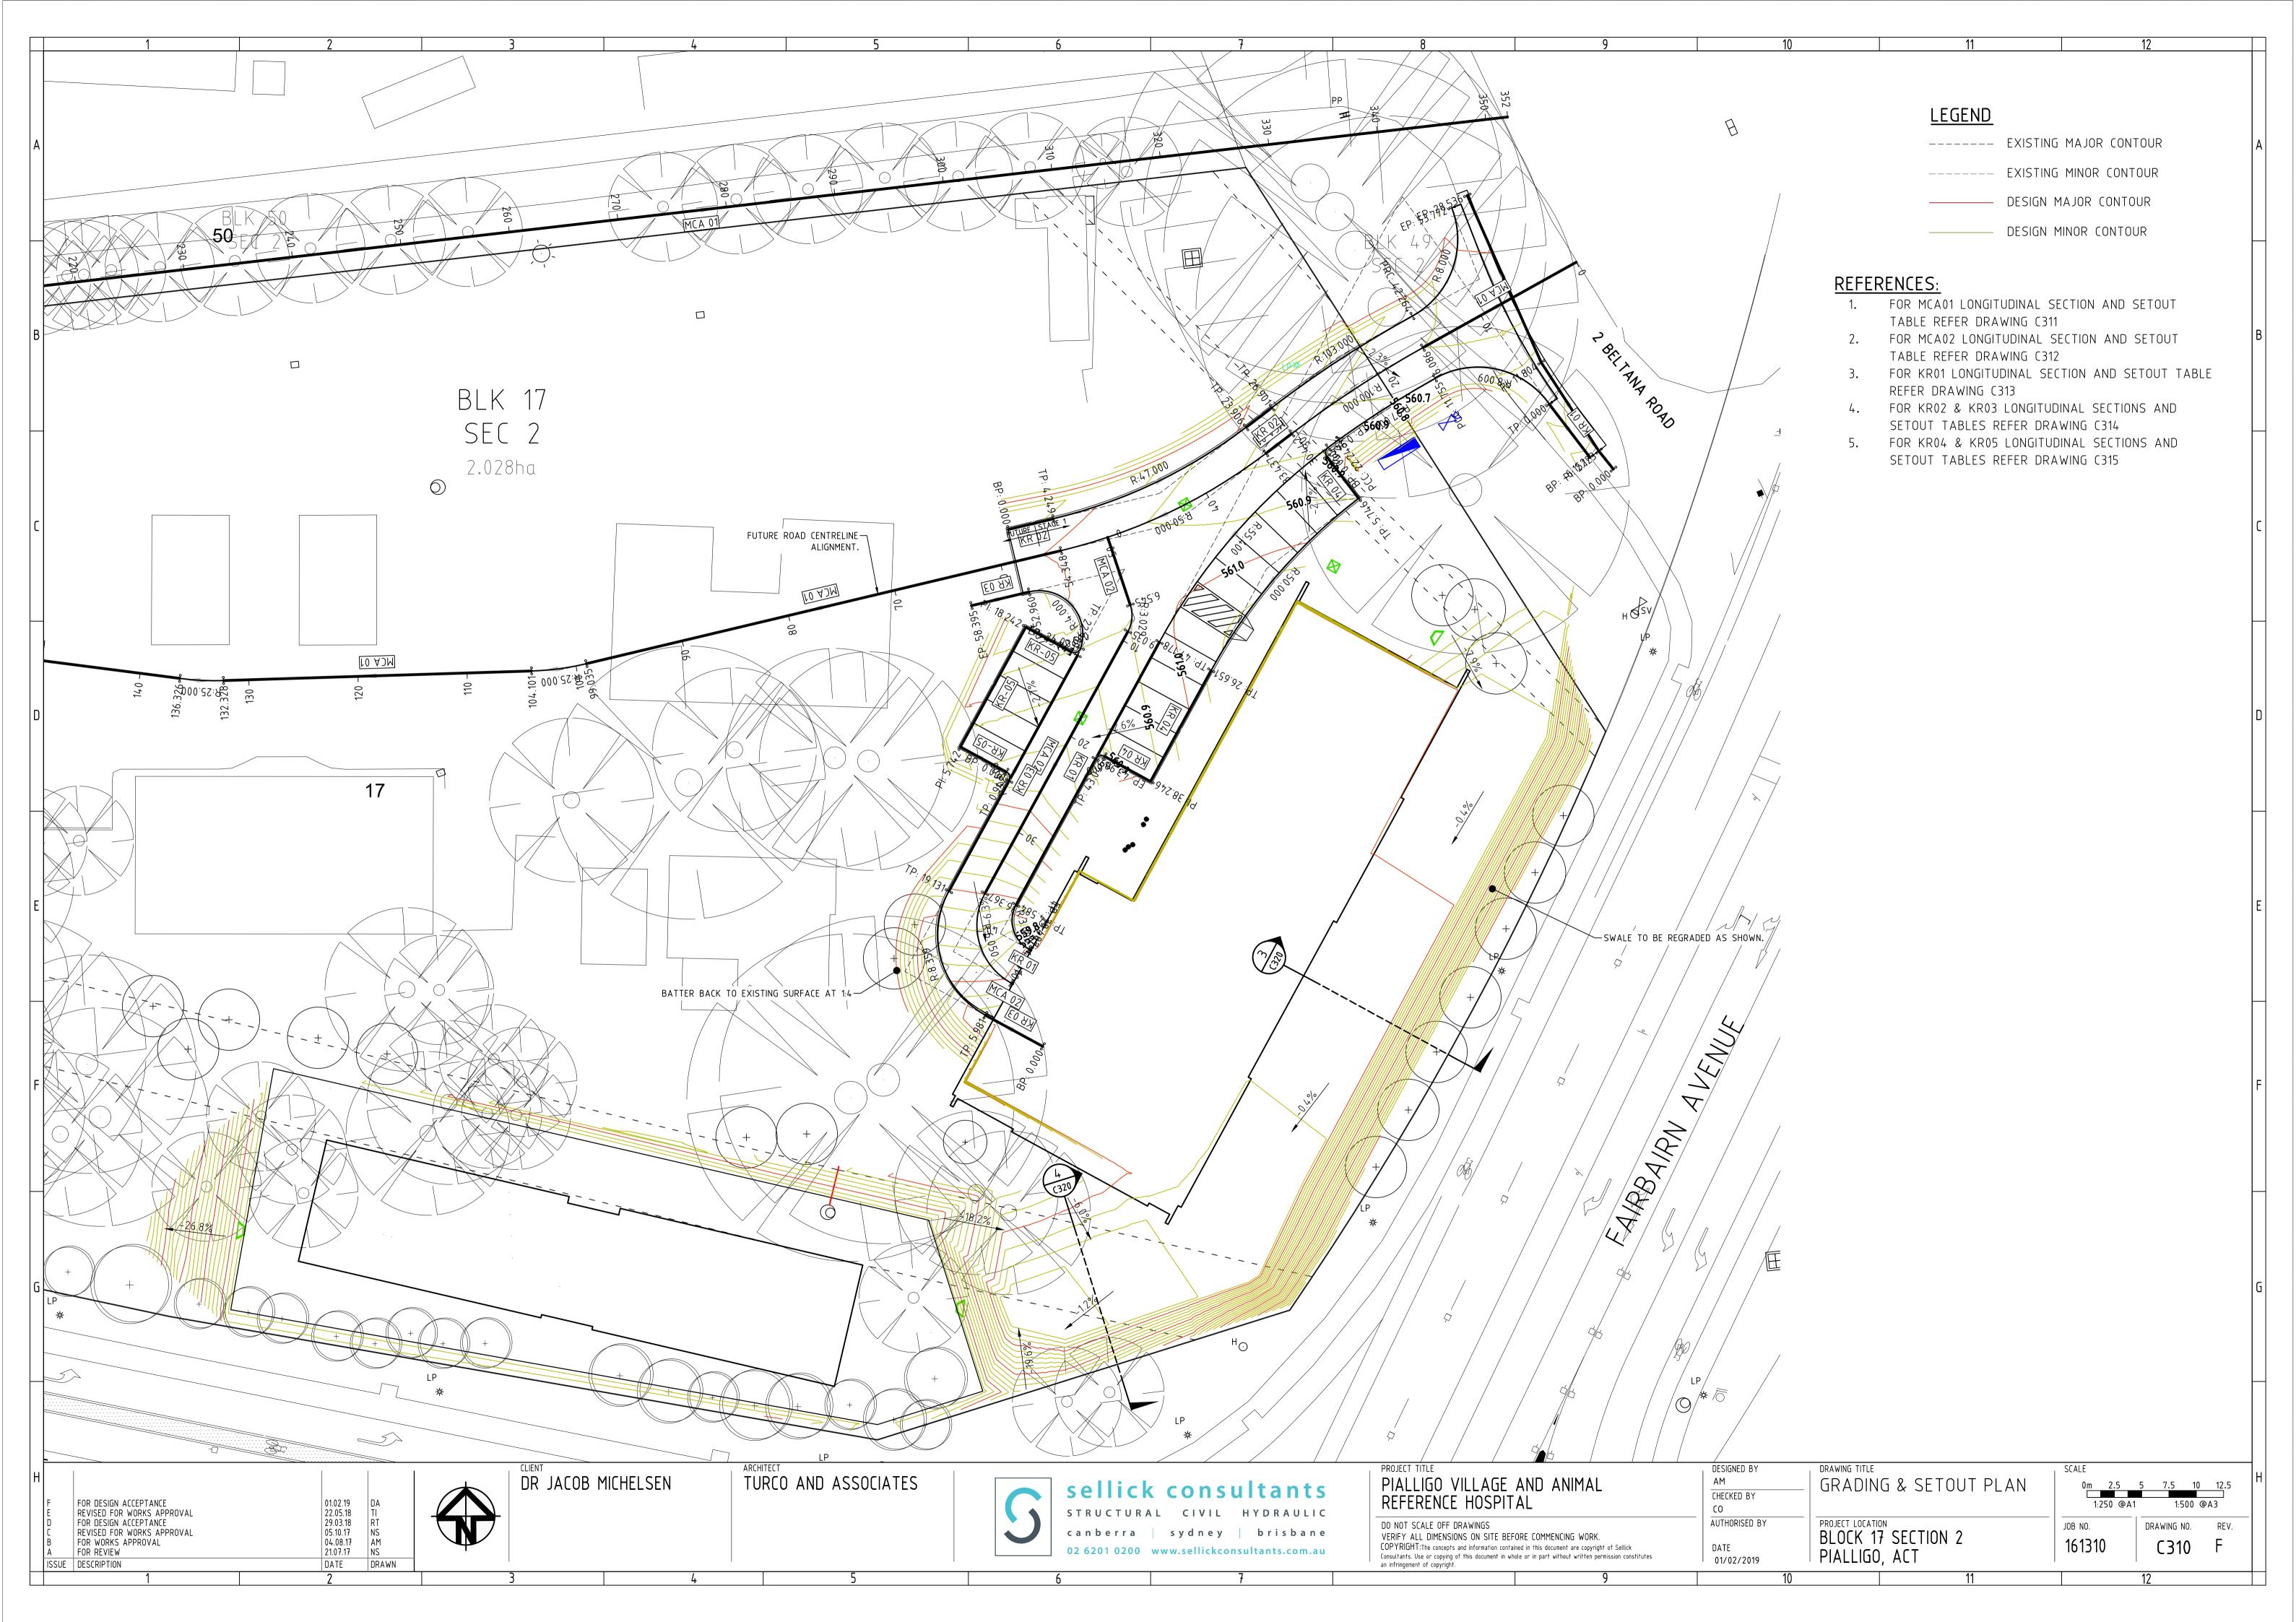

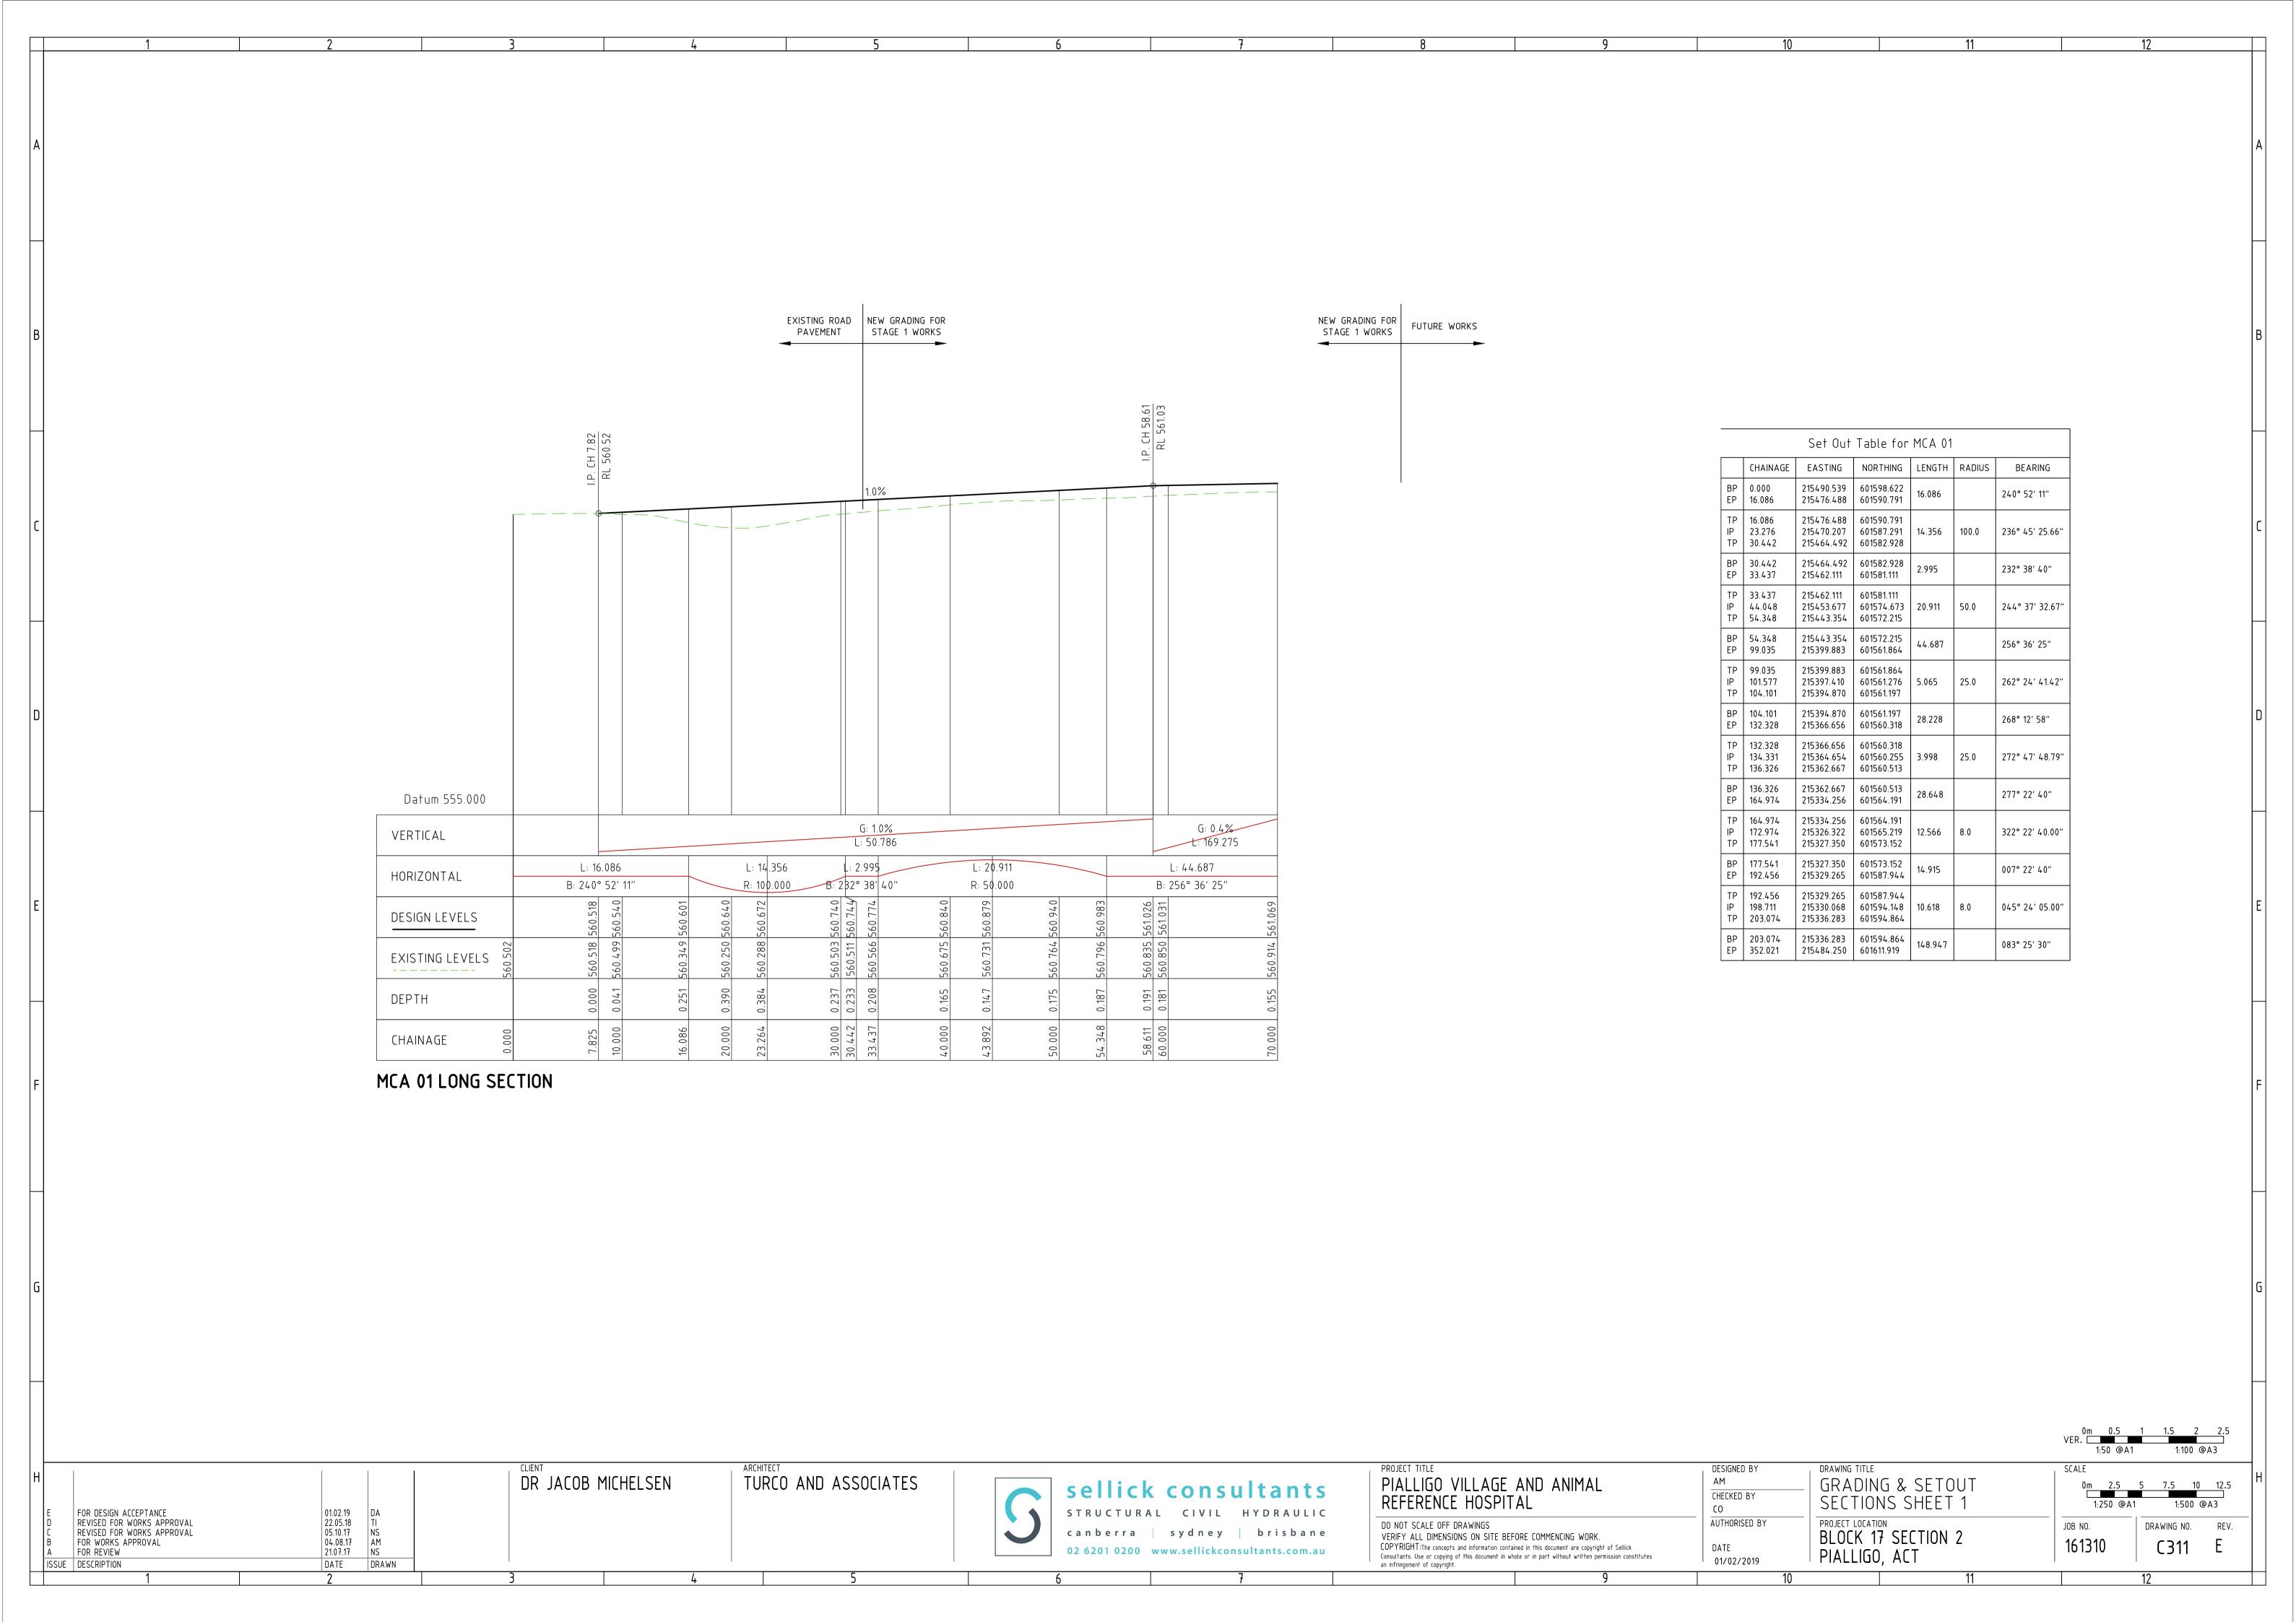



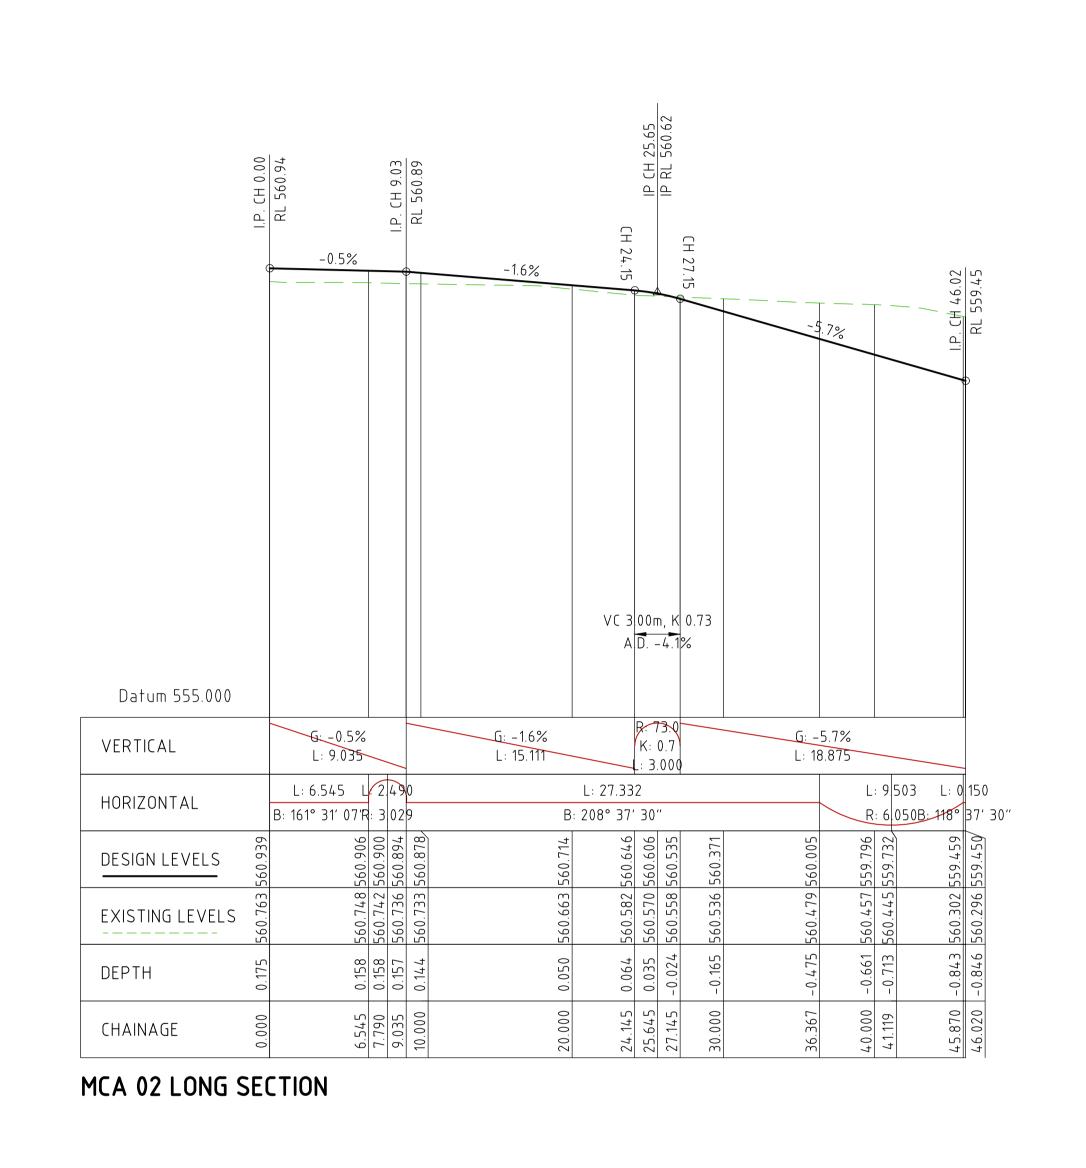

Set Out Table for MCA 02 CHAINAGE EASTING NORTHING LENGTH RADIUS BEARING BP 0.000 EP 6.545 215447.623 601573.434 6.545 215449.697 601567.227 6.545 161° 31′ 07" TP 6.545 IP 7.865 TP 9.035 215449.697 601567.227 215450.116 601565.975 2.490 3.0 215449.483 601564.816 185° 04′ 18.13″ BP 9.035 EP 36.367 215449.483 601564.816 215436.389 601540.824 27.332 208° 37′ 30″ 215436.389 601540.824 IP 42.417 TP 45.870 215433.491 601535.514 9.503 6.0 163° 37′ 29.61″ 215438.801 601532.615 BP 45.870 EP 46.020 215438.801 601532.615 215438.933 601532.544 0.150 118° 37′ 30″


> VER. 0m 0.5 1 1.5 2 2.5 1:50 @A1 1:100 @A3

C FOR DESIGN ACCEPTANCE SERVISED FOR WORKS APPROVAL A FOR DESIGN ACCEPTANCE SERVISED FOR WORKS APPROVAL A FOR DESIGN ACCEPTANCE SOURCE SUBJECT TO SECURITION DATE DRAWN

CLIENT TURCO AND ASSOCIATES

SELLICK CONSULTANTS
STRUCTURAL CIVIL HYDRAULIC Canberra | sydney | brisbane 22.05.18 TI 29.03.18 RT COPYRIGHT: The concepts and information concepts

PROJECT TITLE	DESIGNED BY	DRAWING TITLE	SCALE		
PIALLIUU VILLAUE AND ANIMAL   -	CHECKED BY	GRADING & SETOUT SECTIONS SHEET 2	0m 2.5 1:250 @A1	5 7.5 10 1:500 @	12.5 PA3
VERIFY ALL DIMENSIONS ON SITE BEFORE COMMENCING WORK.  COPYRIGHT: The concepts and information contained in this document are copyright of Sellick  Copyrights. He on copyring of this document in whole on in part without written permission constitutes.	DATE	PROJECT LOCATION BLOCK 17 SECTION 2 PIALLIGO, ACT	JOB NO. 161310	DRAWING NO.	REV.

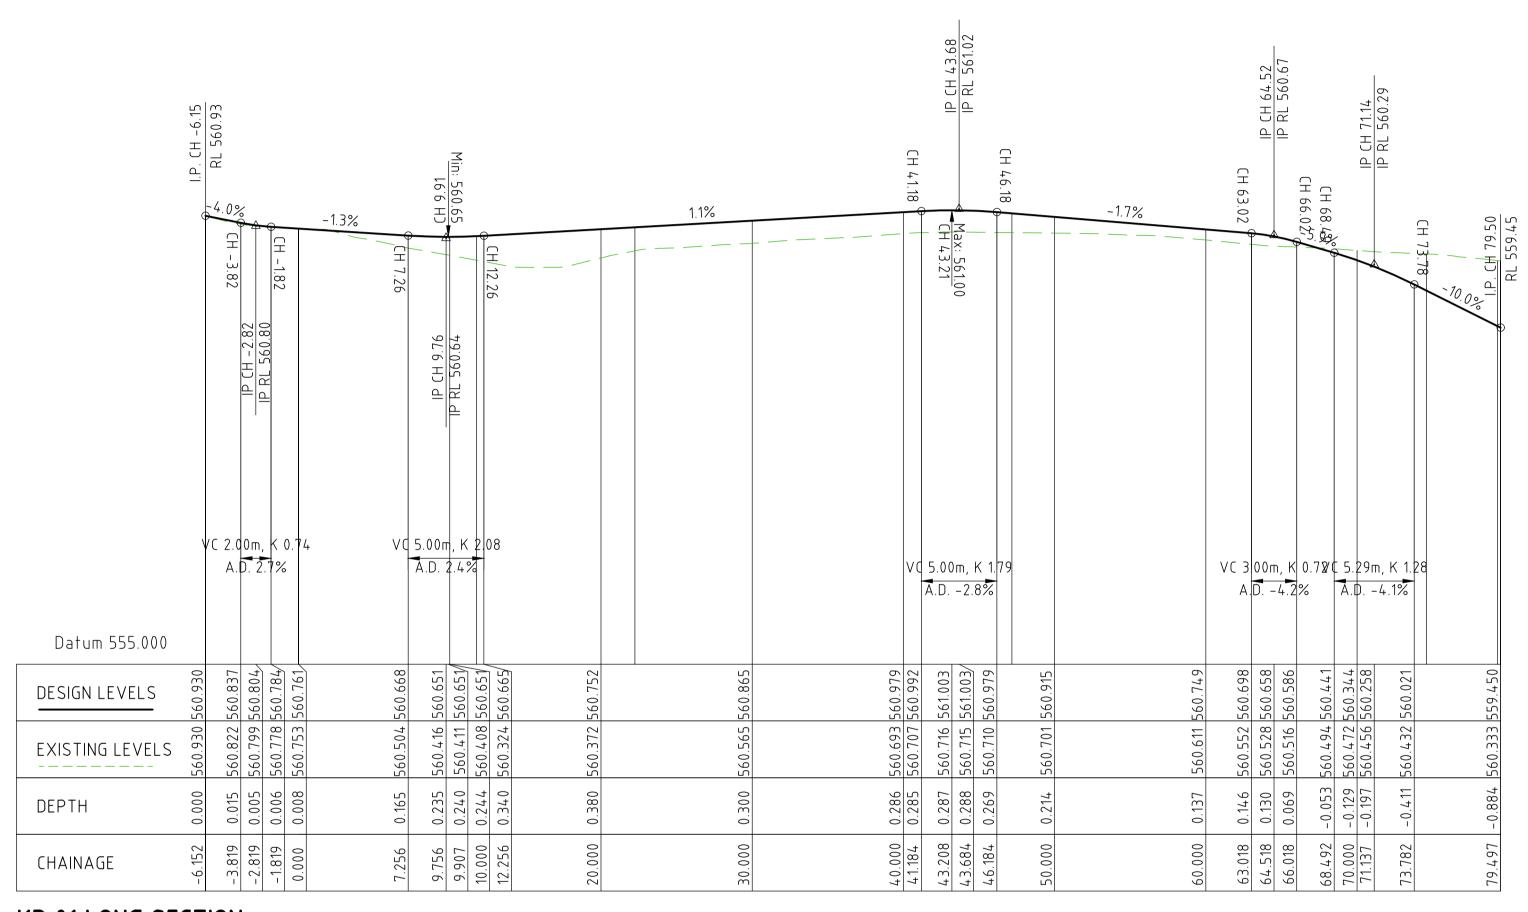

Set Out Table for KR 01									
	CHAINAGE	EASTING	NORTHING	LENGTH	RADIUS	BEARING			
BP EP	-6.152 0.000	215491.798 215488.067	601580.740 601585.631	6.152		322° 39′ 57″			
TP IP TP	0.000 7.224 11.755	215488.067 215483.893 215477.599	601585.631 601591.527 601587.982	11.755	8.0	282° 39′ 17.76″			
TP IP TP	11.755 17.004 22.243	215477.599 215473.026 215468.757	601587.982 601585.406 601582.351	10.488	97.0	237° 30′ 38.28″			
TP IP TP	22.243 34.926 47.178	215468.757 215458.443 215452.368	601582.351 601574.971 601563.838	24.935	55.4	221° 31′ 08.58″			
BP EP	47.178 74.584	215452.368 215439.238	601563.838 601539.782	27.406		208° 37′ 30″			
TP IP TP	74.584 77.584 79.297	215439.238 215437.801 215440.434	601539.782 601537.149 601535.712	4.712	3.0	163° 37′ 29.61″			
BP EP	79.297 79.497	215440.434 215440.610	601535.712 601535.616	0.200		118° 37′ 30″			

KR 01 LONG SECTION

								0m 0.5 1 1.5 2 2.5 VER. 1:50 @A1 1:100 @A3
H		DR JACOB MICHELSEN	TURCO AND ASSOCIATES	sellick consultants  STRUCTURAL CIVIL HYDRAULIC	PROJECT TITLE PIALLIGO VILLAGE AND ANIMAL REFERENCE HOSPITAL		CADING & SETOUT CTIONS SHEET 3	SCALE  0m 2.5 5 7.5 10 12.5  1:250 @A1 1:500 @A3
C FOR DESIGN ACCEPTANCE B REVISED FOR WORKS APPROVAL A FOR DESIGN ACCEPTANCE ISSUE DESCRIPTION	01.02.19 DA 22.05.18 TI 29.03.18 RT DATE DRAWN			canberra   sydney   brisbane 02 6201 0200 www.sellickconsultants.com.au	DO NOT SCALE OFF DRAWINGS  VERIFY ALL DIMENSIONS ON SITE BEFORE COMMENCING WORK.  COPYRIGHT: The concepts and information contained in this document are copyright of Sellick  Consultants. Use or copying of this document in whole or in part without written permission constitutes an infringement of copyright.	BLO	OCK 17 SECTION 2 ALLIGO, ACT	JOB NO. DRAWING NO. REV. C313 C
1	7	3 4	5	6 7	9	10	11	12



sellick consultants

STRUCTURAL CIVIL HYDRAULIC

canberra sydney brisbane

02 6201 0200 www.sellickconsultants.com.au

DR JACOB MICHELSEN

FOR DESIGN ACCEPTANCE REVISED FOR WORKS APPROVAL

FOR DESIGN ACCEPTANCE

ISSUE DESCRIPTION

01.02.19 DA 22.05.18 TI

DATE DRAWN

29.03.18

TURCO AND ASSOCIATES

PROJECT TITLE

DO NOT SCALE OFF DRAWINGS

PIALLIGO VILLAGE AND ANIMAL REFERENCE HOSPITAL

VERIFY ALL DIMENSIONS ON SITE BEFORE COMMENCING WORK.

COPYRIGHT: The concepts and information contained in this document are copyright of Sellick
Consultants. Use or copying of this document in whole or in part without written permission constitutes an infringement of copyright.

0m 0.5 1 1.5 2 2.5 VER. 2 2.5

0m 2.5 5 7.5 10 12.5 1:250 @A1 1:500 @A3

DRAWING NO. REV.

C314 C

1:50 @A1

SCALE

JOB NO.

DRAWING TITLE

PROJECT LOCATION

PIALLIGO, ACT

GRADING & SETOUT

SECTIONS SHEET 4

BLOCK 17 SECTION 2

DESIGNED BY

CHECKED BY


AUTHORISED BY

01/02/2019

AM

CO

DATE

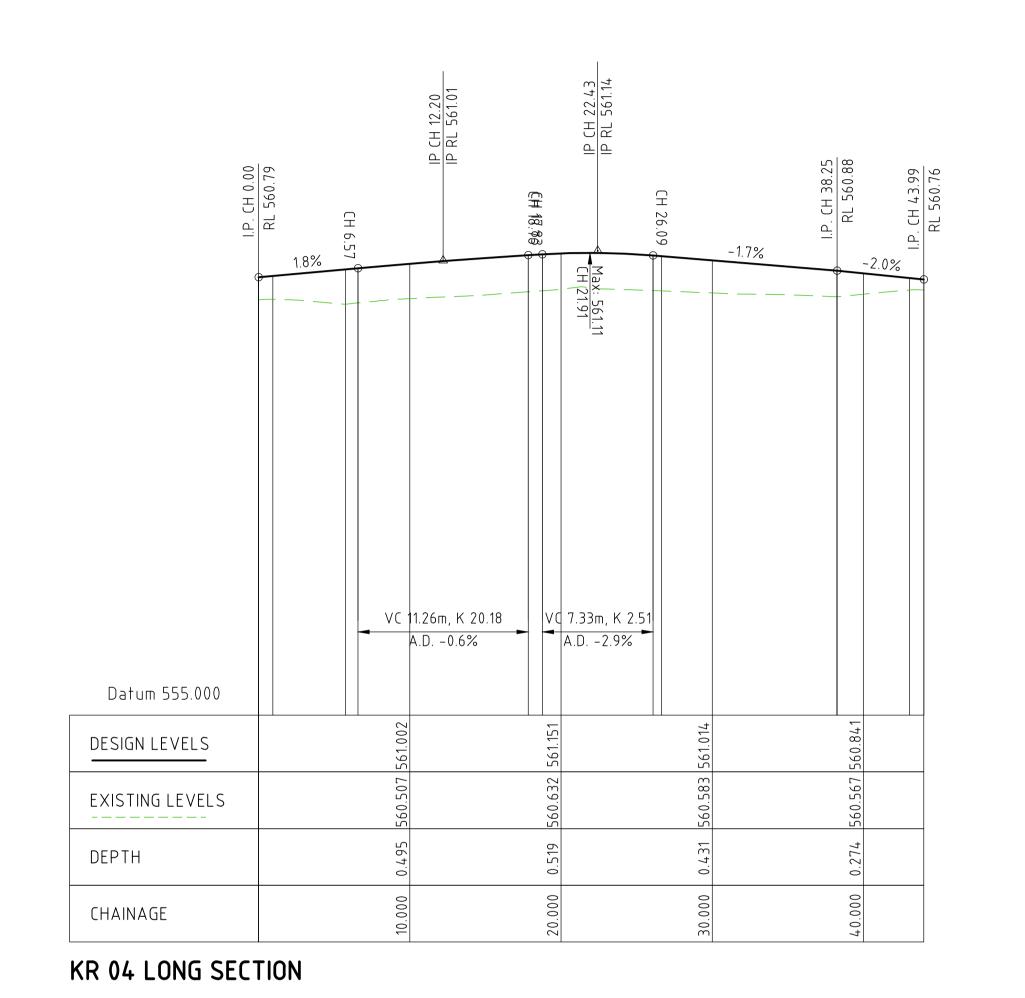

	I.P. CH 0.00 RL 560.63		I.P. CH 18.24	KL 500.99	I.P. LH 24.02 DI 560 90
		1.9%			<b>-</b>
VERT EXAG 1:5 Datum 555.000					
DESIGN LEVELS	560.633	560.841	766.095	560.959	560.900
EXISTING LEVELS	560.606 560.6 560.619 560.6	560.715	560.770 560.9	560.751 560.9	560.740 560.900
DEPTH	0.027	0.126	0.224	0.207	0.161
CHAINAGE	0.000	10.000	18.242	20.000	24.023

Set Out Table for KR 04									
	CHAINAGE	EASTING	NORTHING	LENGTH	RADIUS	BEARING			
TP IP TP	0.000 0.601 0.944	215467.815 215467.334 215467.695	601581.662 601581.302 601580.821	0.944	0.6	188° 08′ 43.67″			
BP EP	0.944 5.746	215467.695 215470.613	601580.821 601577.007	4.803		142° 34′ 47″			
TP IP TP	5.746 16.353 26.651	215470.613 215462.189 215457.107	601577.007 601570.561 601561.250	20.905	50.0	220° 36′ 08.25″			
BP EP	26.651 38.246	215457.107 215451.552	601561.250 601551.072	11.595		208° 37′ 30″			
BP EP	38.246 43.046	215451.552 215447.339	601551.072 601553.372	4.800		298° 37′ 30″			
TP IP TP	43.046 43.646 43.989	215447.339 215446.812 215446.525	601553.372 601553.659 601553.132	0.942	0.6	253° 37′ 15.90″			

Set Out Table for KR-05										
CHAINAGE EASTING NORTHING LENGTH RADIUS BEARING										
TP IP TP	0.000 0.600 0.942	215438.596 215438.883 215438.357	601551.130 601551.656 601551.944	0.942	0.6	343° 37′ 29.61″				
BP EP	0.942 5.742	215438.357 215434.143	601551.944 601554.243	4.800		298° 37′ 30″				
BP EP	5.742 18.242	215434.143 215440.132	601554.243 601565.215	12.500		028° 37′ 30″				
BP EP	18.242 22.989	215440.132 215444.298	601565.215 601562.941	4.747		118° 37′ 30″				
TP IP TP	22.989 23.689 24.023	215444.298 215444.912 215445.150	601562.941 601562.606 601563.264	1.034	0.6	069° 14′ 57.53"				

KR-05 LONG SECTION

					U	
PROJECT TITLE	DESIGNED BY	DRAWING TITLE	SCALE			],,
PIALLIGO VILLAGE AND ANIMAL	AM	GRADING & SETOUT	0m 2.5	5 7.5 10	12.5	ПП
	CHECKED BY					
REFERENCE HOSPITAL	СО	SECTIONS SHEET 5	1:250 @A	1 1:500 (	⊕A3	
DO NOT SCALE OFF DRAWINGS	AUTHORISED BY	PROJECT LOCATION	JOB NO.	DRAWING NO.	REV.	
VERIFY ALL DIMENSIONS ON SITE BEFORE COMMENCING WORK.		BLOCK 17 SECTION 2		6745	_	
COPYRIGHT: The concepts and information contained in this document are copyright of Sel		DIVITION VCT	161310	C315	L	

								1:50 @A1 1:100 @A3
H		DR JACOB MICHELSEN	TURCO AND ASSOCIATES	sellick consultants  STRUCTURAL CIVIL HYDRAULIC	PROJECT TITLE PIALLIGO VILLAGE AND ANIMAL REFERENCE HOSPITAL	DESIGNED BY  AM  CHECKED BY  CO	DRAWING TITLE  GRADING & SETOUT  SECTIONS SHEET 5	SCALE  0m 2.5 5 7.5 10 12.5  1:250 @A1 1:500 @A3
C FOR DESIGN ACCEPTANCE B REVISED FOR WORKS APPROVAL A FOR DESIGN ACCEPTANCE ISSUE DESCRIPTION	01.02.19 DA 22.05.18 TI 29.03.18 RT DATE DRAWN			canberra   sydney   brisbane 02 6201 0200 www.sellickconsultants.com.au	DO NOT SCALE OFF DRAWINGS  VERIFY ALL DIMENSIONS ON SITE BEFORE COMMENCING WORK.  COPYRIGHT: The concepts and information contained in this document are copyright of Sellick  Consultants. Use or copying of this document in whole or in part without written permission constitutes an infringement of copyright.	DATE 01/02/2019	PROJECT LOCATION BLOCK 17 SECTION 2 PIALLIGO, ACT	JOB NO.   DRAWING NO. REV.   C315   C
1	2	3	5	6 7	9	10	) 11	12

